# Improvements to

# Fairhope Tennis Addition

Fairhope, Alabama

Prepared for City of Fairhope

Fairhope, Alabama

Prepared by






Jinright & Associates Development Engineers 208 Greeno Road North Fairhope, Alabama 36532 P.O. Box 1929 Fairhope, Alabama 36533 251.928.3443(tel) 251.928.3665(fax) jadengineers.com

TIM KANT, MAYOR

Fairhope City Council Jack Burrell, President Kevin G. Boone Diana J. Brewer Michael A. Ford, A.C.M.O. Richard A. Mueller, Sr.

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BID NO: 012-15 JULY 2015

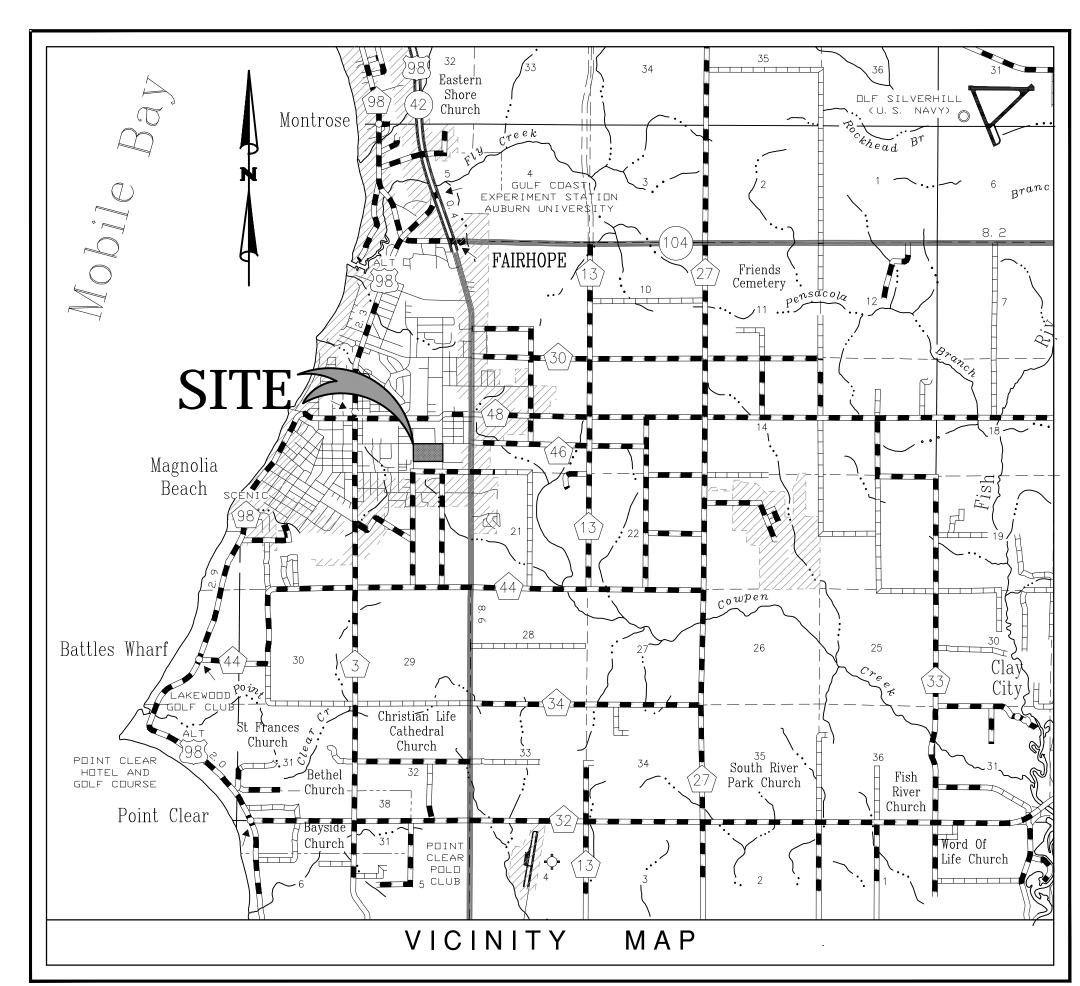

Not to Scale

# ARREVIATION I ECEND

	ABBREVIAT	TON LEG	<del>i</del> END
ALUM	ALUMINUM	LP	LOW POINT
AC	ACRES	LT	LEFT
ACCMP	ASPHALT-COATED	LIN	LINER
	ASPHALT—COATED CORRUGATED METAL PIPE	LF	LINEAR FEET
ACP	ASBESTOS CEMENT PIPE	LC	LANDSCAPE CONTRACTOR
APPROX	APPROXIMATE(LY)	LA	LANDSCAPE ARCHITECT
B&B	BALLED AND BURLAPPED	М	METER
BC	BOTTOM OF CURB	MAX	MAXIMUM
BIT	BITUMINOUS	MH	MANHOLE
ВМ	BENCHMARK	MIN	MINIMUM
BLDG	BUILDING	MISC	MISCELLANEOUS
BS	BOTTOM OF SLOPE	MON	MONUMENT
BVC	BEGINNING OF VERTICAL CURVE	N	NORTH
BW	BOTH WAYS	NIC NTS	NOT IN CONTRACT NOT TO SCALE
CAL CB	CALIPER	NO	NUMBER
CI	CATCH BASIN	NOM	NOMINAL DIMENSION
CIR	CAST IRON CIRCULAR	OC	ON CENTER
CL	CENTEDI INIE	OD	OUTSIDE DIAMETER
CLF	CHAIN-LINK FENCE	PA	PLANTING AREA
CO	CLEANOUT	PCP	POROUS CONCRETE PIPE
CM	CENTIMETER	PVC	POLYVINYL CHLORIDE PIPE
CMP	CORRUGATED METAL PIPE	PC	POINT OF CURVATURE
COL	COLUMN	PCC	POINT OF COMPOUND
CONC	CONCRETE		CURVATURE
CONT'R	CONTRACTOR	PL	PROPERTY LINE
COR	CORNER	PVC	POINT OF VERTICAL CURVATURE
C/S	CROSS SLOPE	PVT	POINT OF VERTICAL TANGENT
C/W	CONNECTED WITH	PT	POINT OF TANGENT
CF	CUBIC FEET	R	RADIUS
CY	CUBIC YARD	RCP	REINFORCED CONCRETE PIPE
D	DEGREE OF CURVATURE	ROW	RIGHT OF WAY
DETL	DETAIL	RT	RIGHT
DMH	DROP MANHOLE	REQD REV	REQUIRED REVISION
DF	DRINKING FOUNTAIN	REINF	REINFORCED
DIM	DIMENSION	SAN	SANITARY
DIA	DIAMETER	SECT	SECTION
DWG	DRAWING	SH	SHEET
DEP	DEPARTURE	S	SOUTH
DIR	DIRECTED ELECTRICAL	SI	STORM INLET
DIR -E- E	ELECTRICAL	-ST-	STORM INLET STORM SEWER SANITARY SEWER
EA	EAST EACH	-SAN-	SANITARY SEWER
FC	ELECTRICAL CONTRACTOR	SPEC	SPECIFICATIONS OR SPECIFIED
FI	EACH ELECTRICAL CONTRACTOR ELEVATION EXPOSED AGGREGATE PAVING END OF VERTICAL CURVE ENGINEER	ST'L	STEEL
EAP	EXPOSED AGGREGATE PAVING	SQ	SQUARE SQUARE FOOT SQUARE YARD
EVC	END OF VERTICAL CURVE	SF	SQUARE FOOT
ENGR	ENGINEER	SY STA	SQUARE YARD
EX	EXISTING	317	STATION
EXP	EXPANSION	S_S	STAINLESS STEEL
EW	END WALL END SECTION		TELEPHONE
ES_	END SECTION	T	TANGENT
FFE	FINISHED FLOOR ELEVATION	TE	TOP OF CURB TAPERED END
FG	FINISHED GRADE	TCP	TERRA-COTTA PIPE
· IN	FINISH	T&G	TONGUE AND GROOVE
- L - i i	FLUUK	TW	
「	FIRE HIDRAINI FLOW LINE	TS	TOP OF SLOPE
FSD	FILL -SIZED DETAIL	TS TWP	TOWNSHIP
FTG	FOOTING	TYP	TYPICAL
FT	FOOT OR FEFT	UD	UNDFRDRAIN
GA	GAUGE	USGS	US GEOLOGICAL SURVEY
-G-	GAS	VC	VERTICAL CURVE
GAL	FINISHED FLOOR ELEVATION FINISHED GRADE FINISH FLOOR FIRE HYDRANT FLOW LINE FULL—SIZED DETAIL FOOTING FOOT OR FEET GAUGE GAS GALLON GALVANIZED GENERAL CONTRACTOR GUARD RAIL GRADE GAS VALVE	VAR	VERTICAL CURVE VARIES, VARIABLE VERTICAL
GALV	GALVANIZED	VERT	VERTICAL
GC	GENERAL CONTRACTOR	VCP	
GR	GUARD RAIL	_W_	WATER
GD	GRADE	W	
<b>.</b> .	0/10 1/1E1E	W/	WITH
HB	HOSE BIB HEAD WALL	W/O WWM	WITHOUT
		WWM	WOVEN WIRE MESH
HP	HIGH POINT	WV	WATER VALVE
HT	HEIGHT	YD	YARD DRAIN
HOR HWY ID	HORIZONTAL	d	POLIND DIAMETED
HWY ID	HIGHWAY INSIDE DIAMETER	ø ©	ROUND DIAMETER AT
IN	INSIDE DIAMETER	Ψ,	
in INL	INLET	"	FEET
	INVERT		INCHES
JB	JUNCTION BOX	#1 **	NUMBER
	LENGTH OF CURVE	1#	POUND
LAT	LATITUDE		

# UTILITY INFORMATION:

CONTRACTOR SHALL HAVE ALL EXISTING BURIED UTILITIES "LINE SPOTTED" BY CALLING 1-800-292-8525 "ALABAMA ONE-CALL" OR BY CONTACTING LOCAL UTILITY COMPANIES.

WATER, SEWER, GAS FAIRHOPE PUBLIC UTILITIES 555 SOUTH SECTION STREET

FAIRHOPE, ALABAMA 36533 251.928.8003

WATER AND SEWER: DAN McCRORY

GAS: ROBERT ROHM

POWER: SCOTT SLIGH


TELEPHONE: AT&T 2001 MAIN STREET DAPHNE, ALABAMA 36526 251.626.2913

NOTE: NO CONSTRUCTION AND/OR LAND DISTURBANCE, EXCEPT THOSE NECESSARY TO INSTALLED AND APPROVED BY THE CITY/COUNTY

> PERRY C. JINRIGHT, III, P.E. ALA. LIC. NO. 25748

DATE




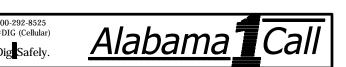

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	07.10.15	ISSUED FOR BID
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**COVER SHEET** 






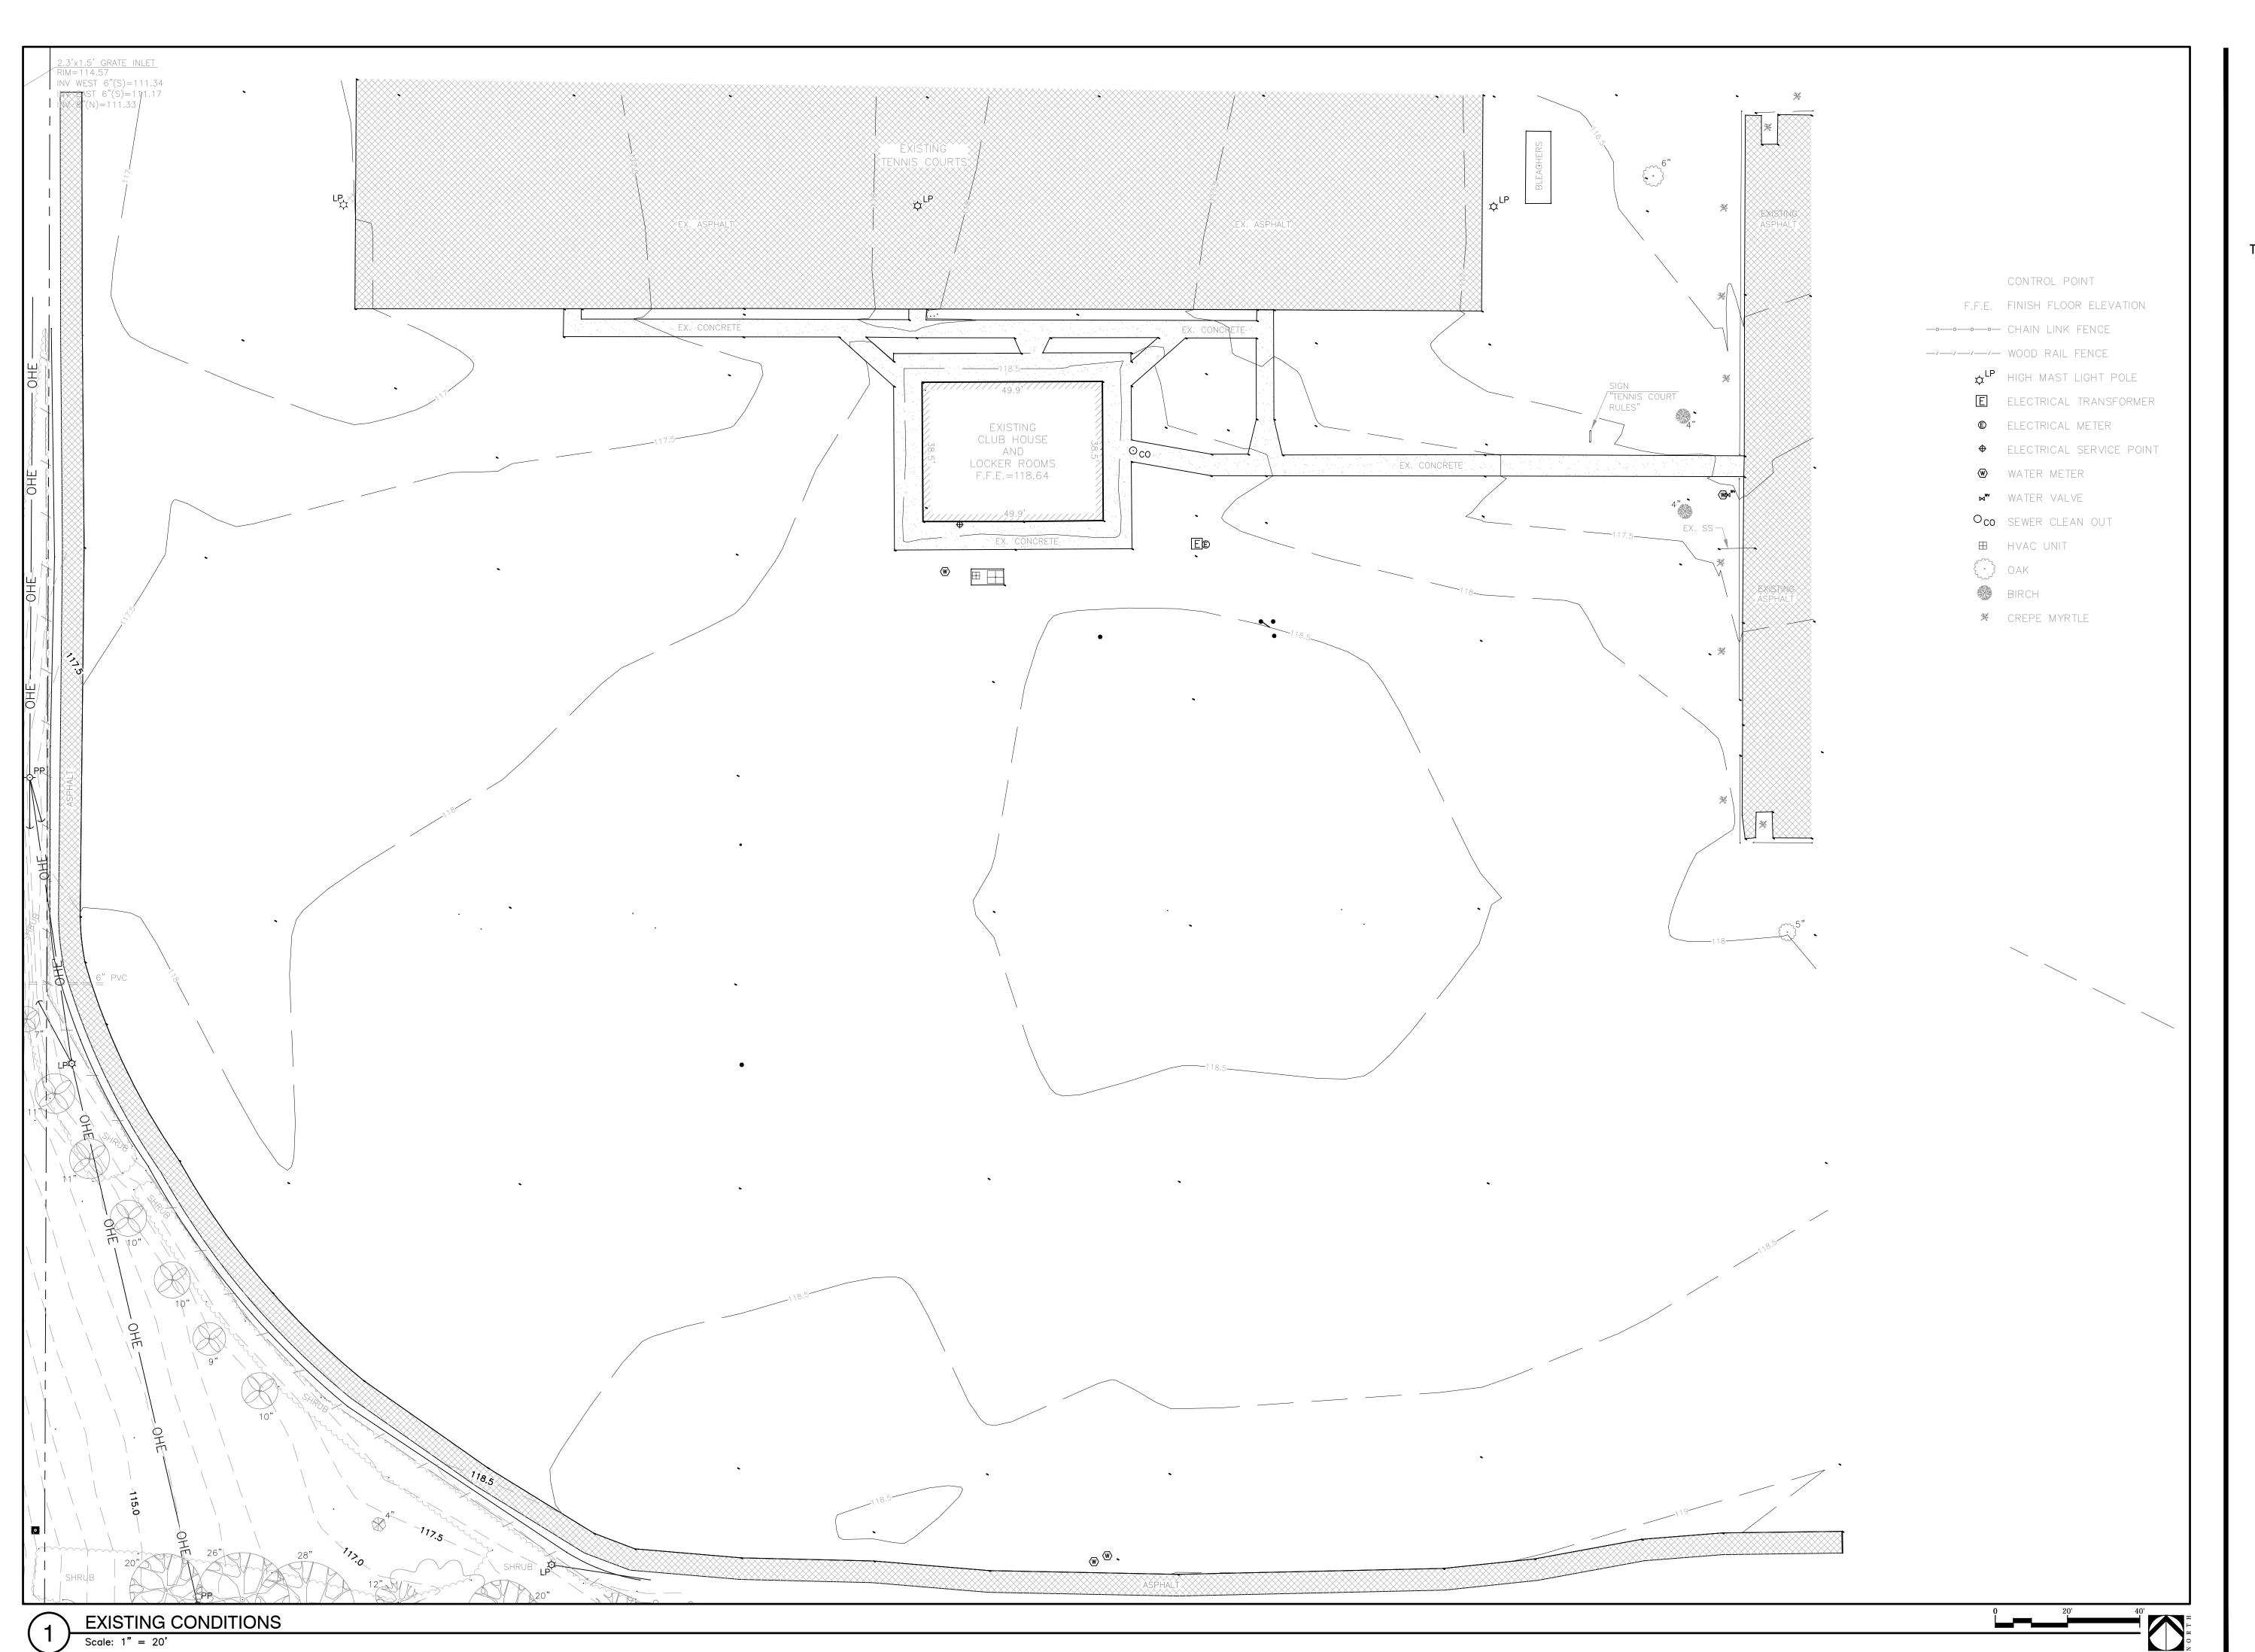

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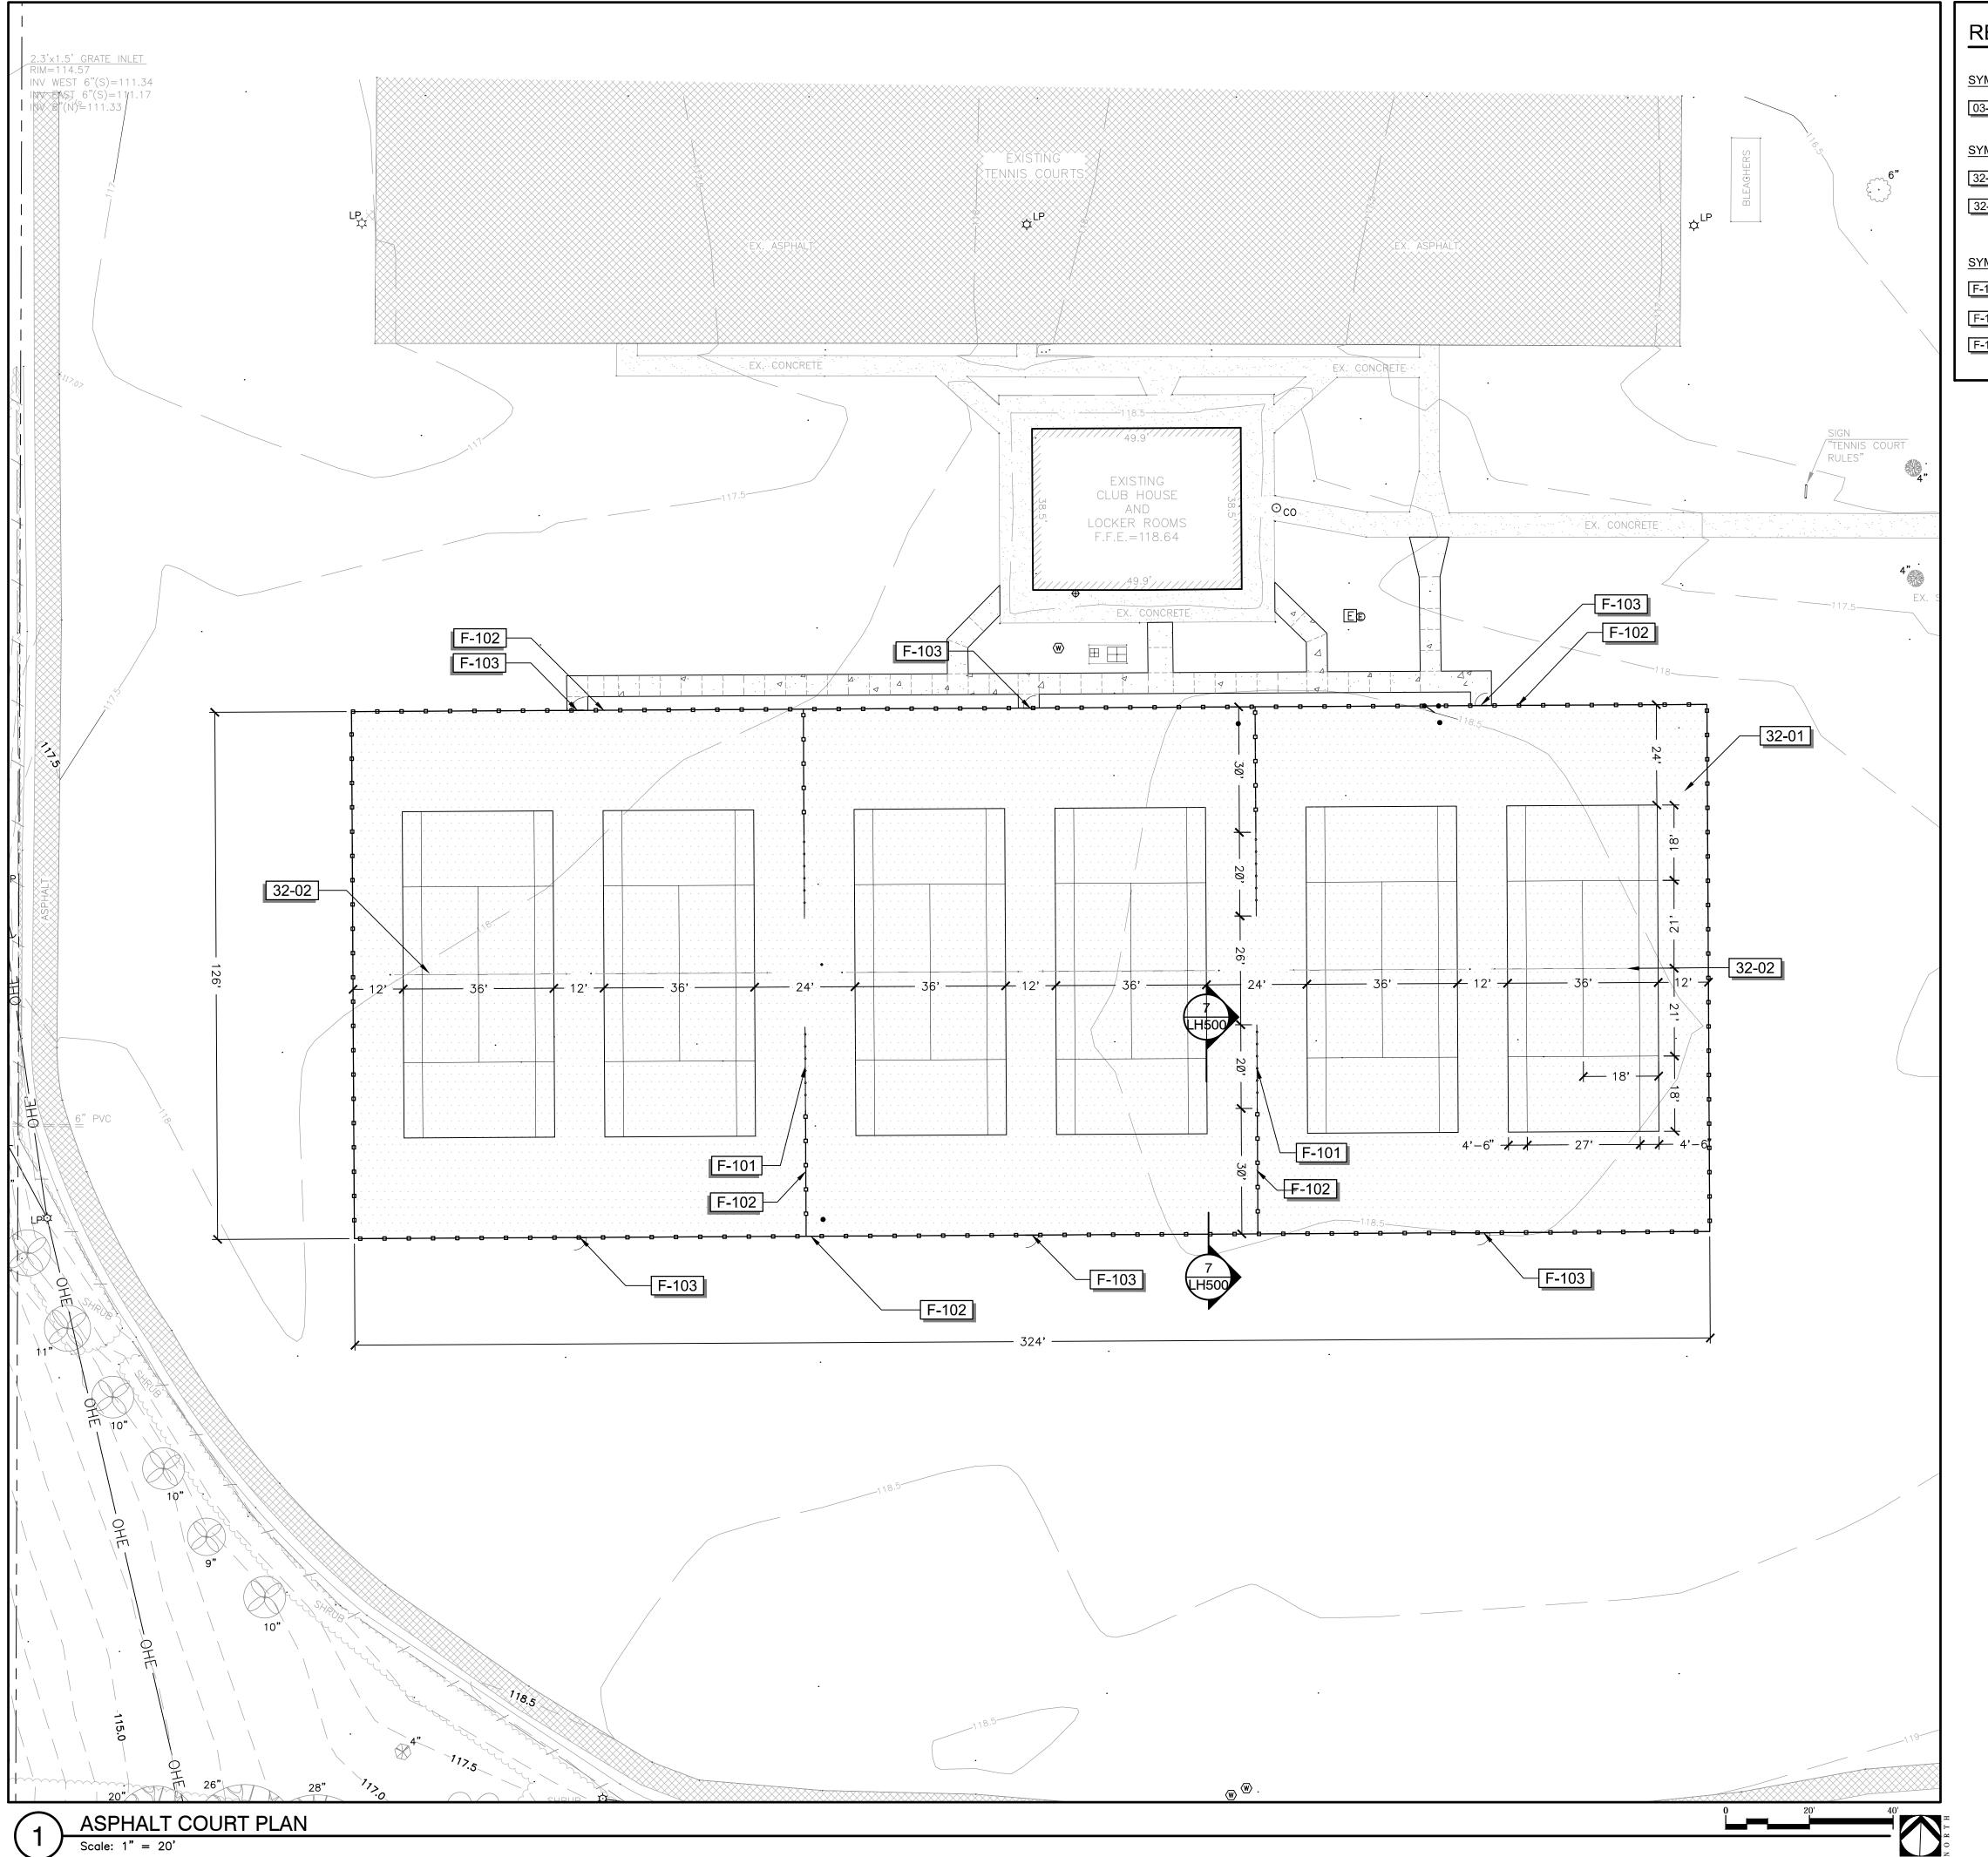
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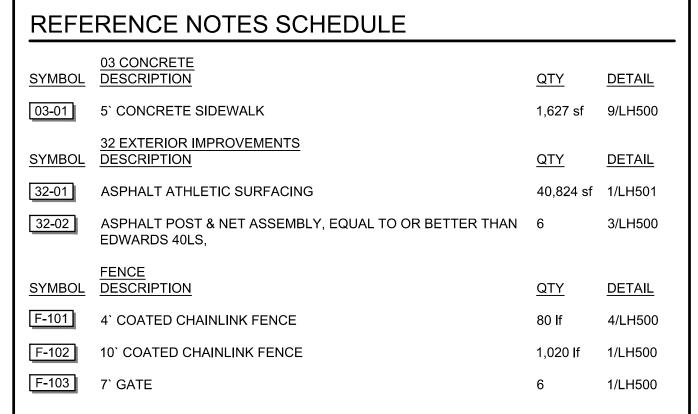
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EXISTING CONDITIONS

CV100



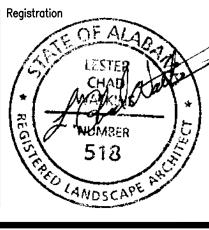





Stimpson Park Tenuis Courts


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Revisions / Submissions

ASHPALT COURT PLAN

Sheet No. SP100



WATKINS • ACY • STRUNK landscape architecture • land planning • placemaking

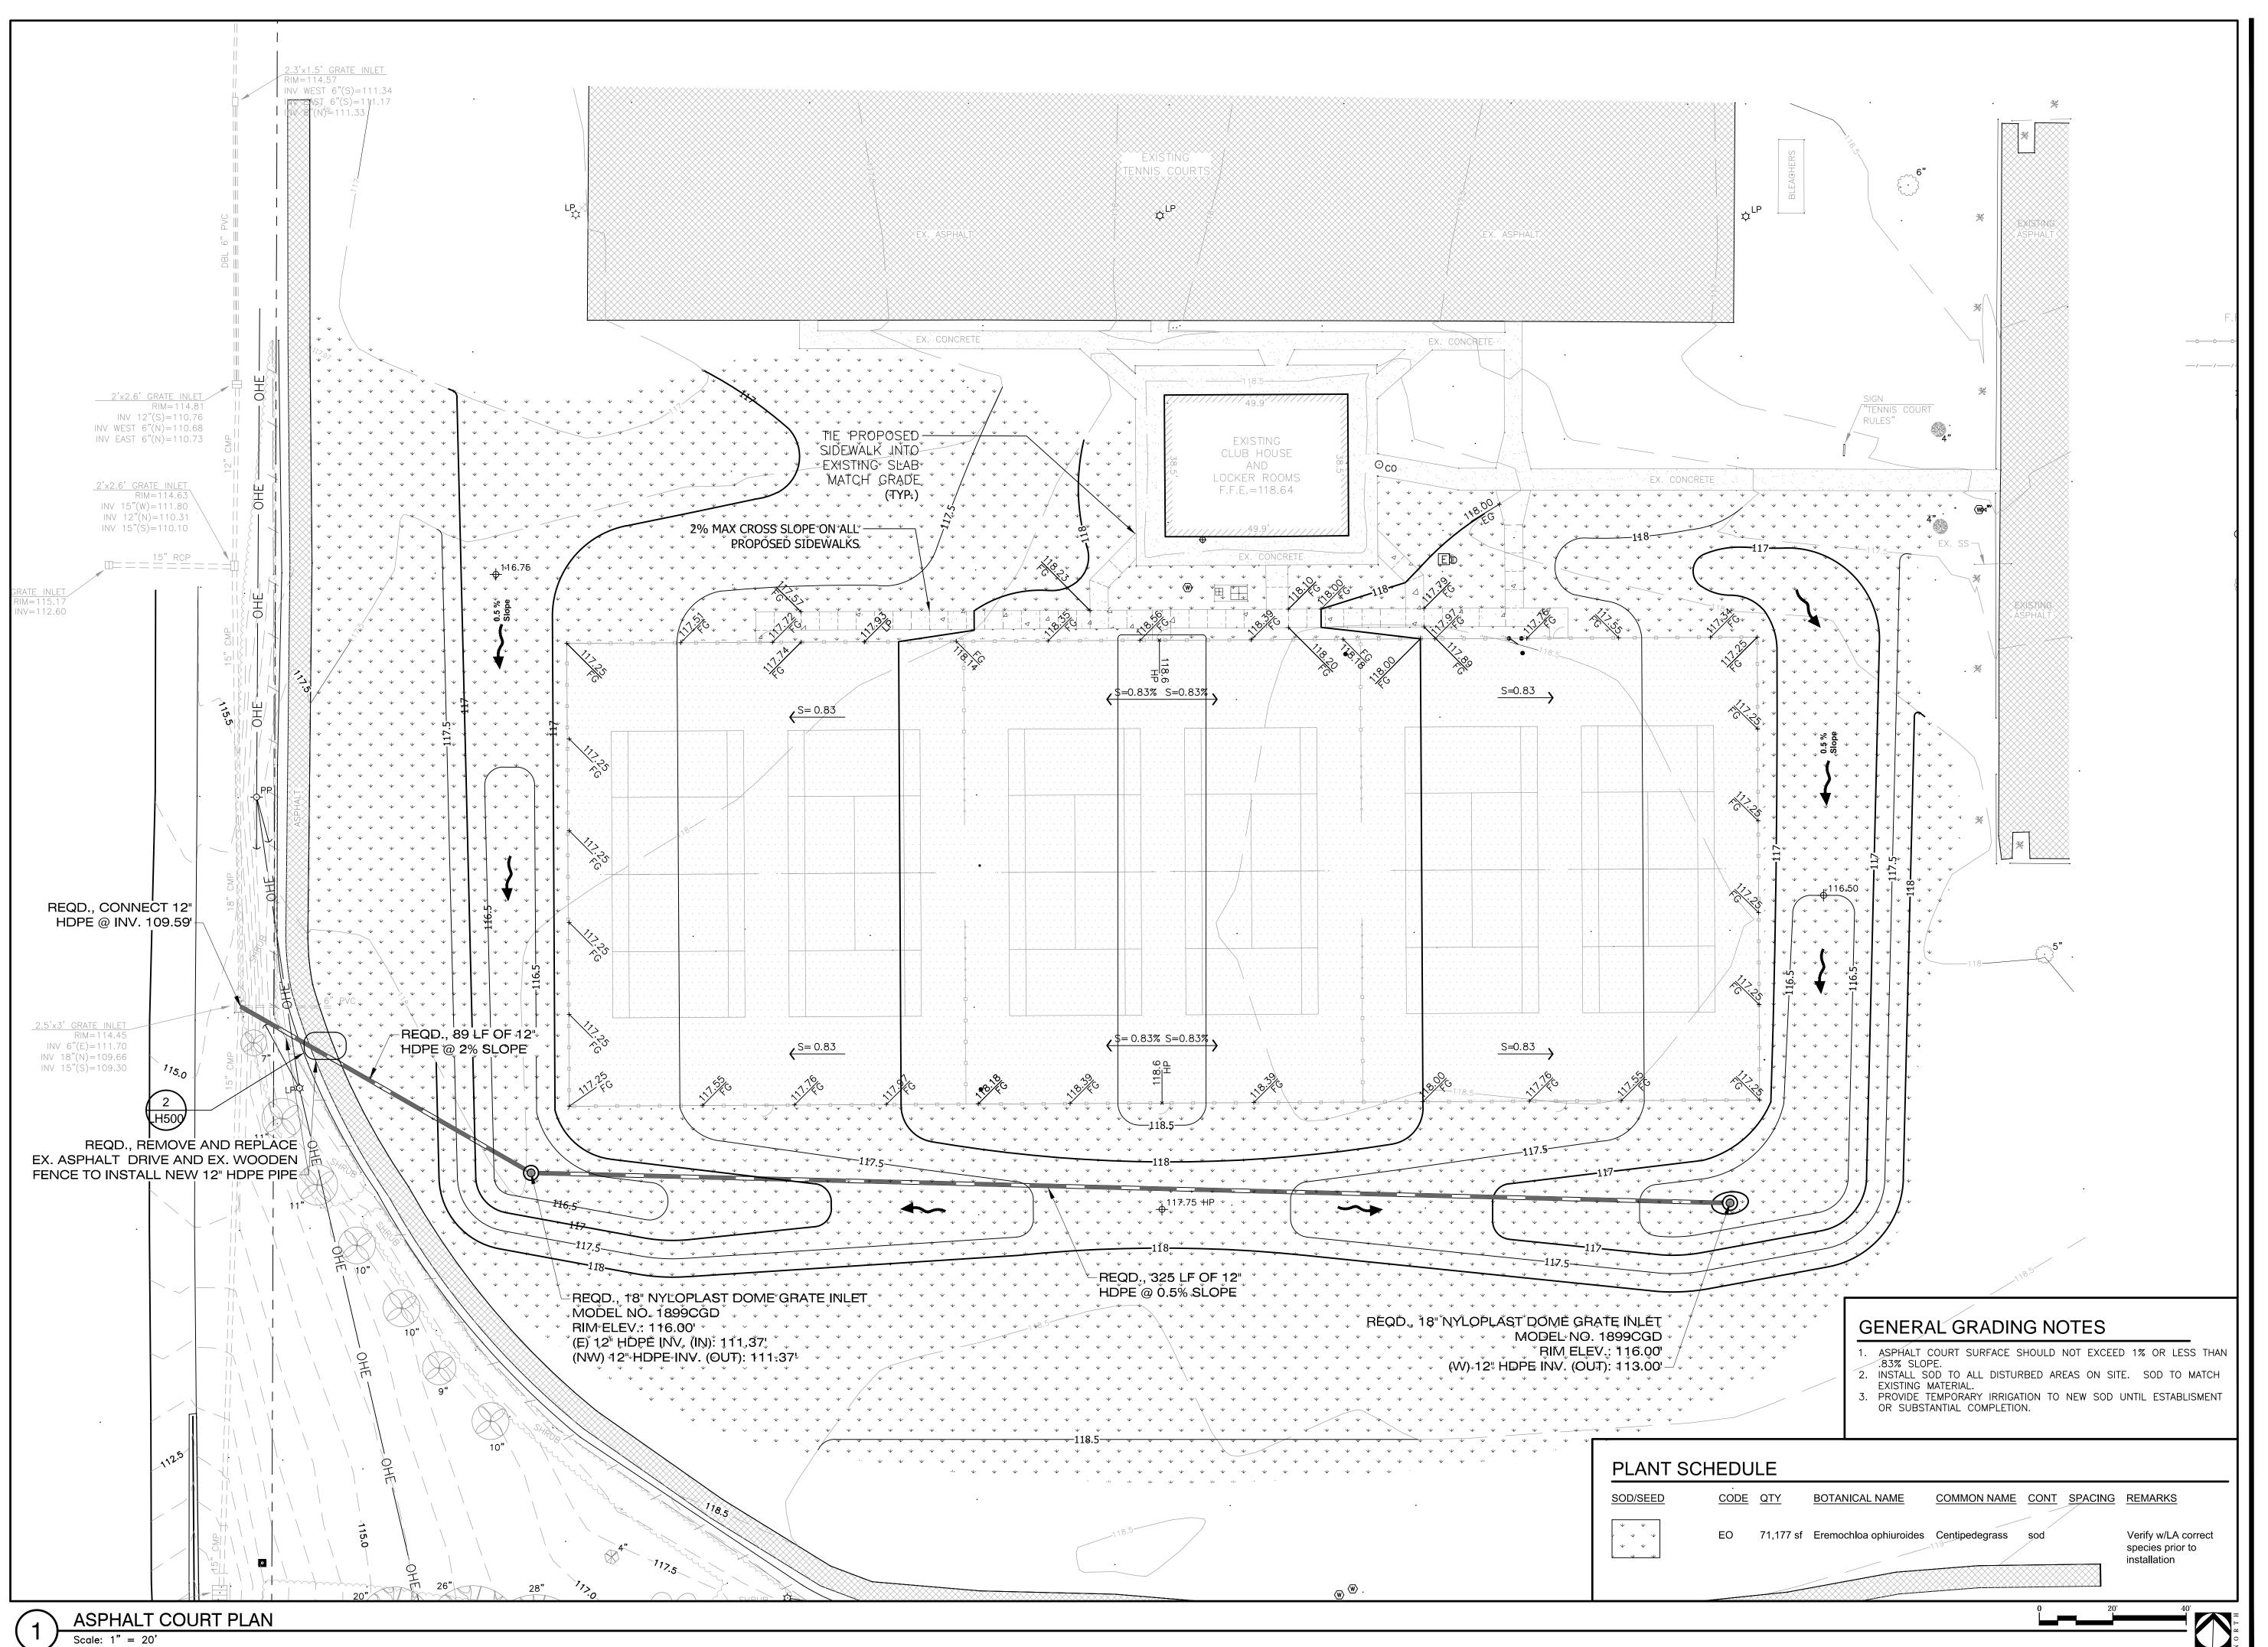218 N. Alston Street, Foley, Alabama 36535
Telephone 251.948.7181 Facsimile 251.981.8722
www.was-design.com

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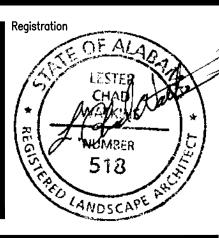
Stimpson Park Tenuis Court

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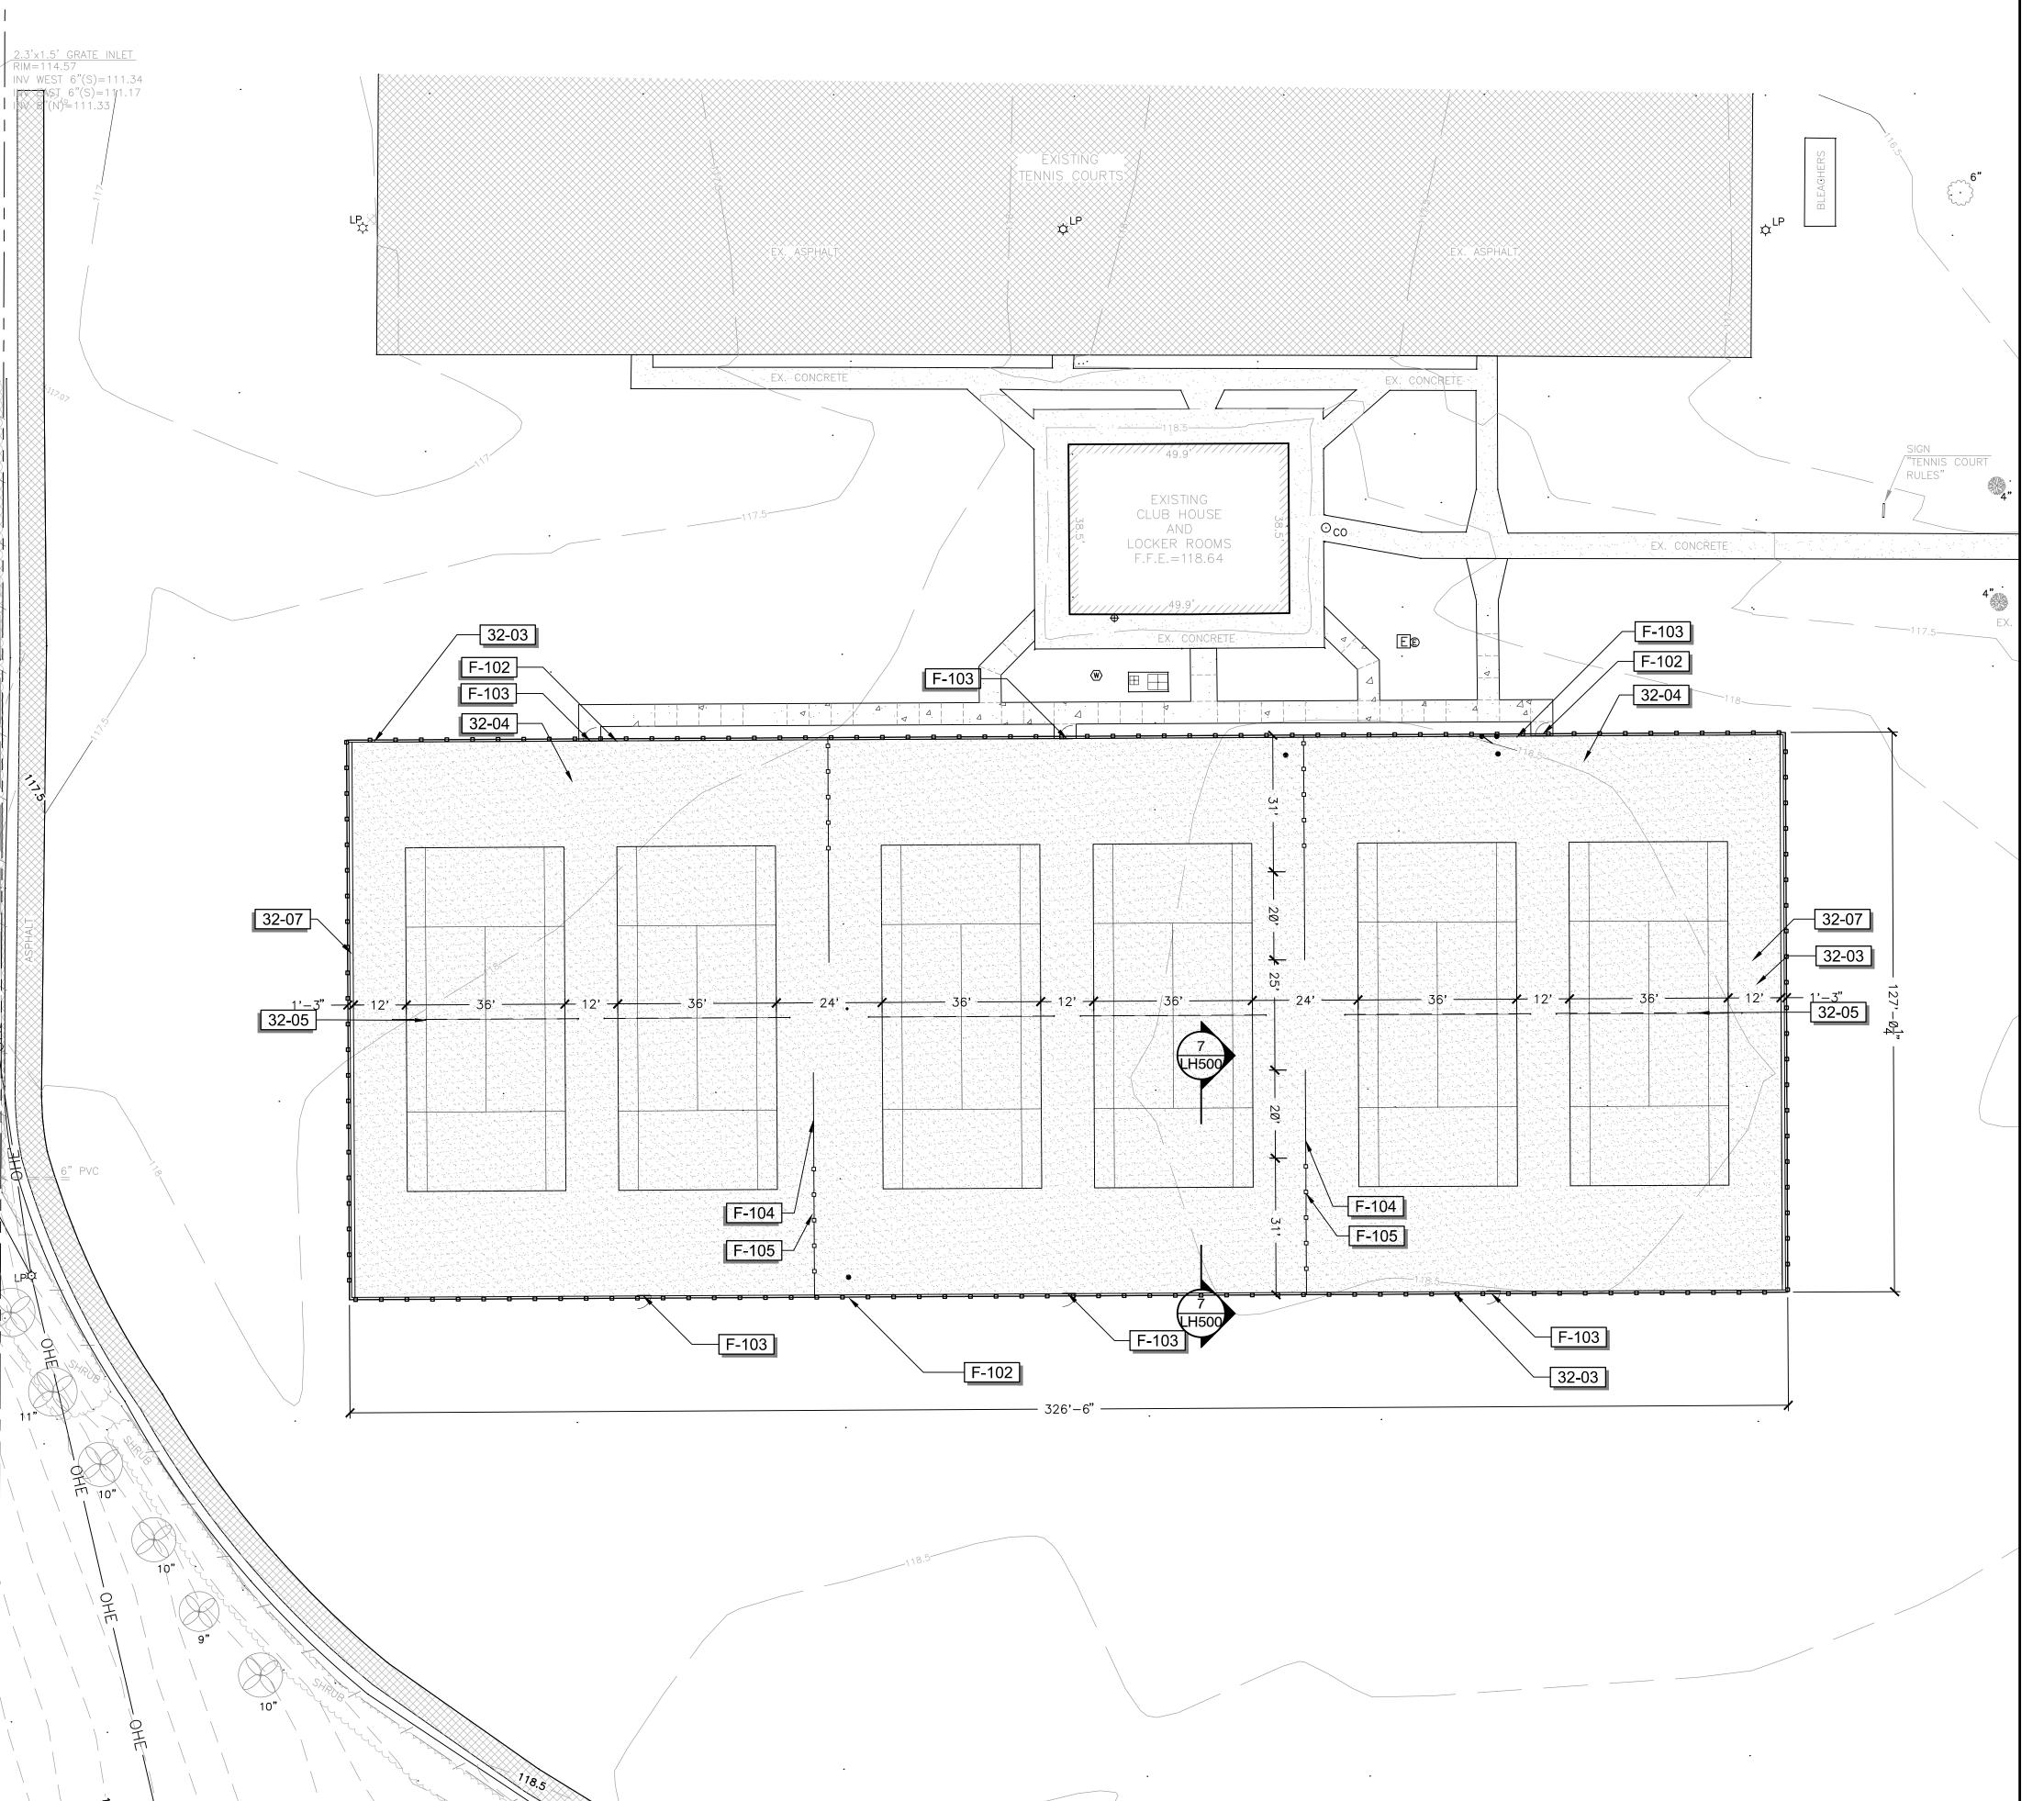
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Project No.
2/5/15



ASPHALT COURT GRADING PLAN

LG100



REFE	RENCE NOTES SCHEDULE		
SYMBOL	03 CONCRETE DESCRIPTION	<u>QTY</u>	DETAIL
03-01	5` CONCRETE SIDEWALK	1,627 sf	9/LH500
SYMBOL	32 EXTERIOR IMPROVEMENTS DESCRIPTION	QTY	<u>DETAIL</u>
32-03	6" CONCRETE CURB	905 If	2/LH501
32-04	HYDROCOURT ATHLETIC SURFACING	40,832 sf	2/LH501
32-05	CLAY POST & NET ASSEMBLY, EQUAL TO OR BETTER THAN EDWARDS 40LS,	6	5/LH500
32-07	6" PRO SERIES TRENCH DRAIN	252 If	8/LH500
SYMBOL	FENCE DESCRIPTION	<u>QTY</u>	DETAIL
F-102	10' COATED CHAINLINK FENCE	907 If	1/LH500
F-103	7` GATE	6	1/LH500
F-104	4` COATED CHAINLINK FENCE ON CLAY	80 If	6/LH500
F-105	10' COATED CHAINLINK FENCE ON CLAY	124 If	






Stimpson Park Tenuis Courts

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HYDROCOURT PLAN

Sheet No. SP101



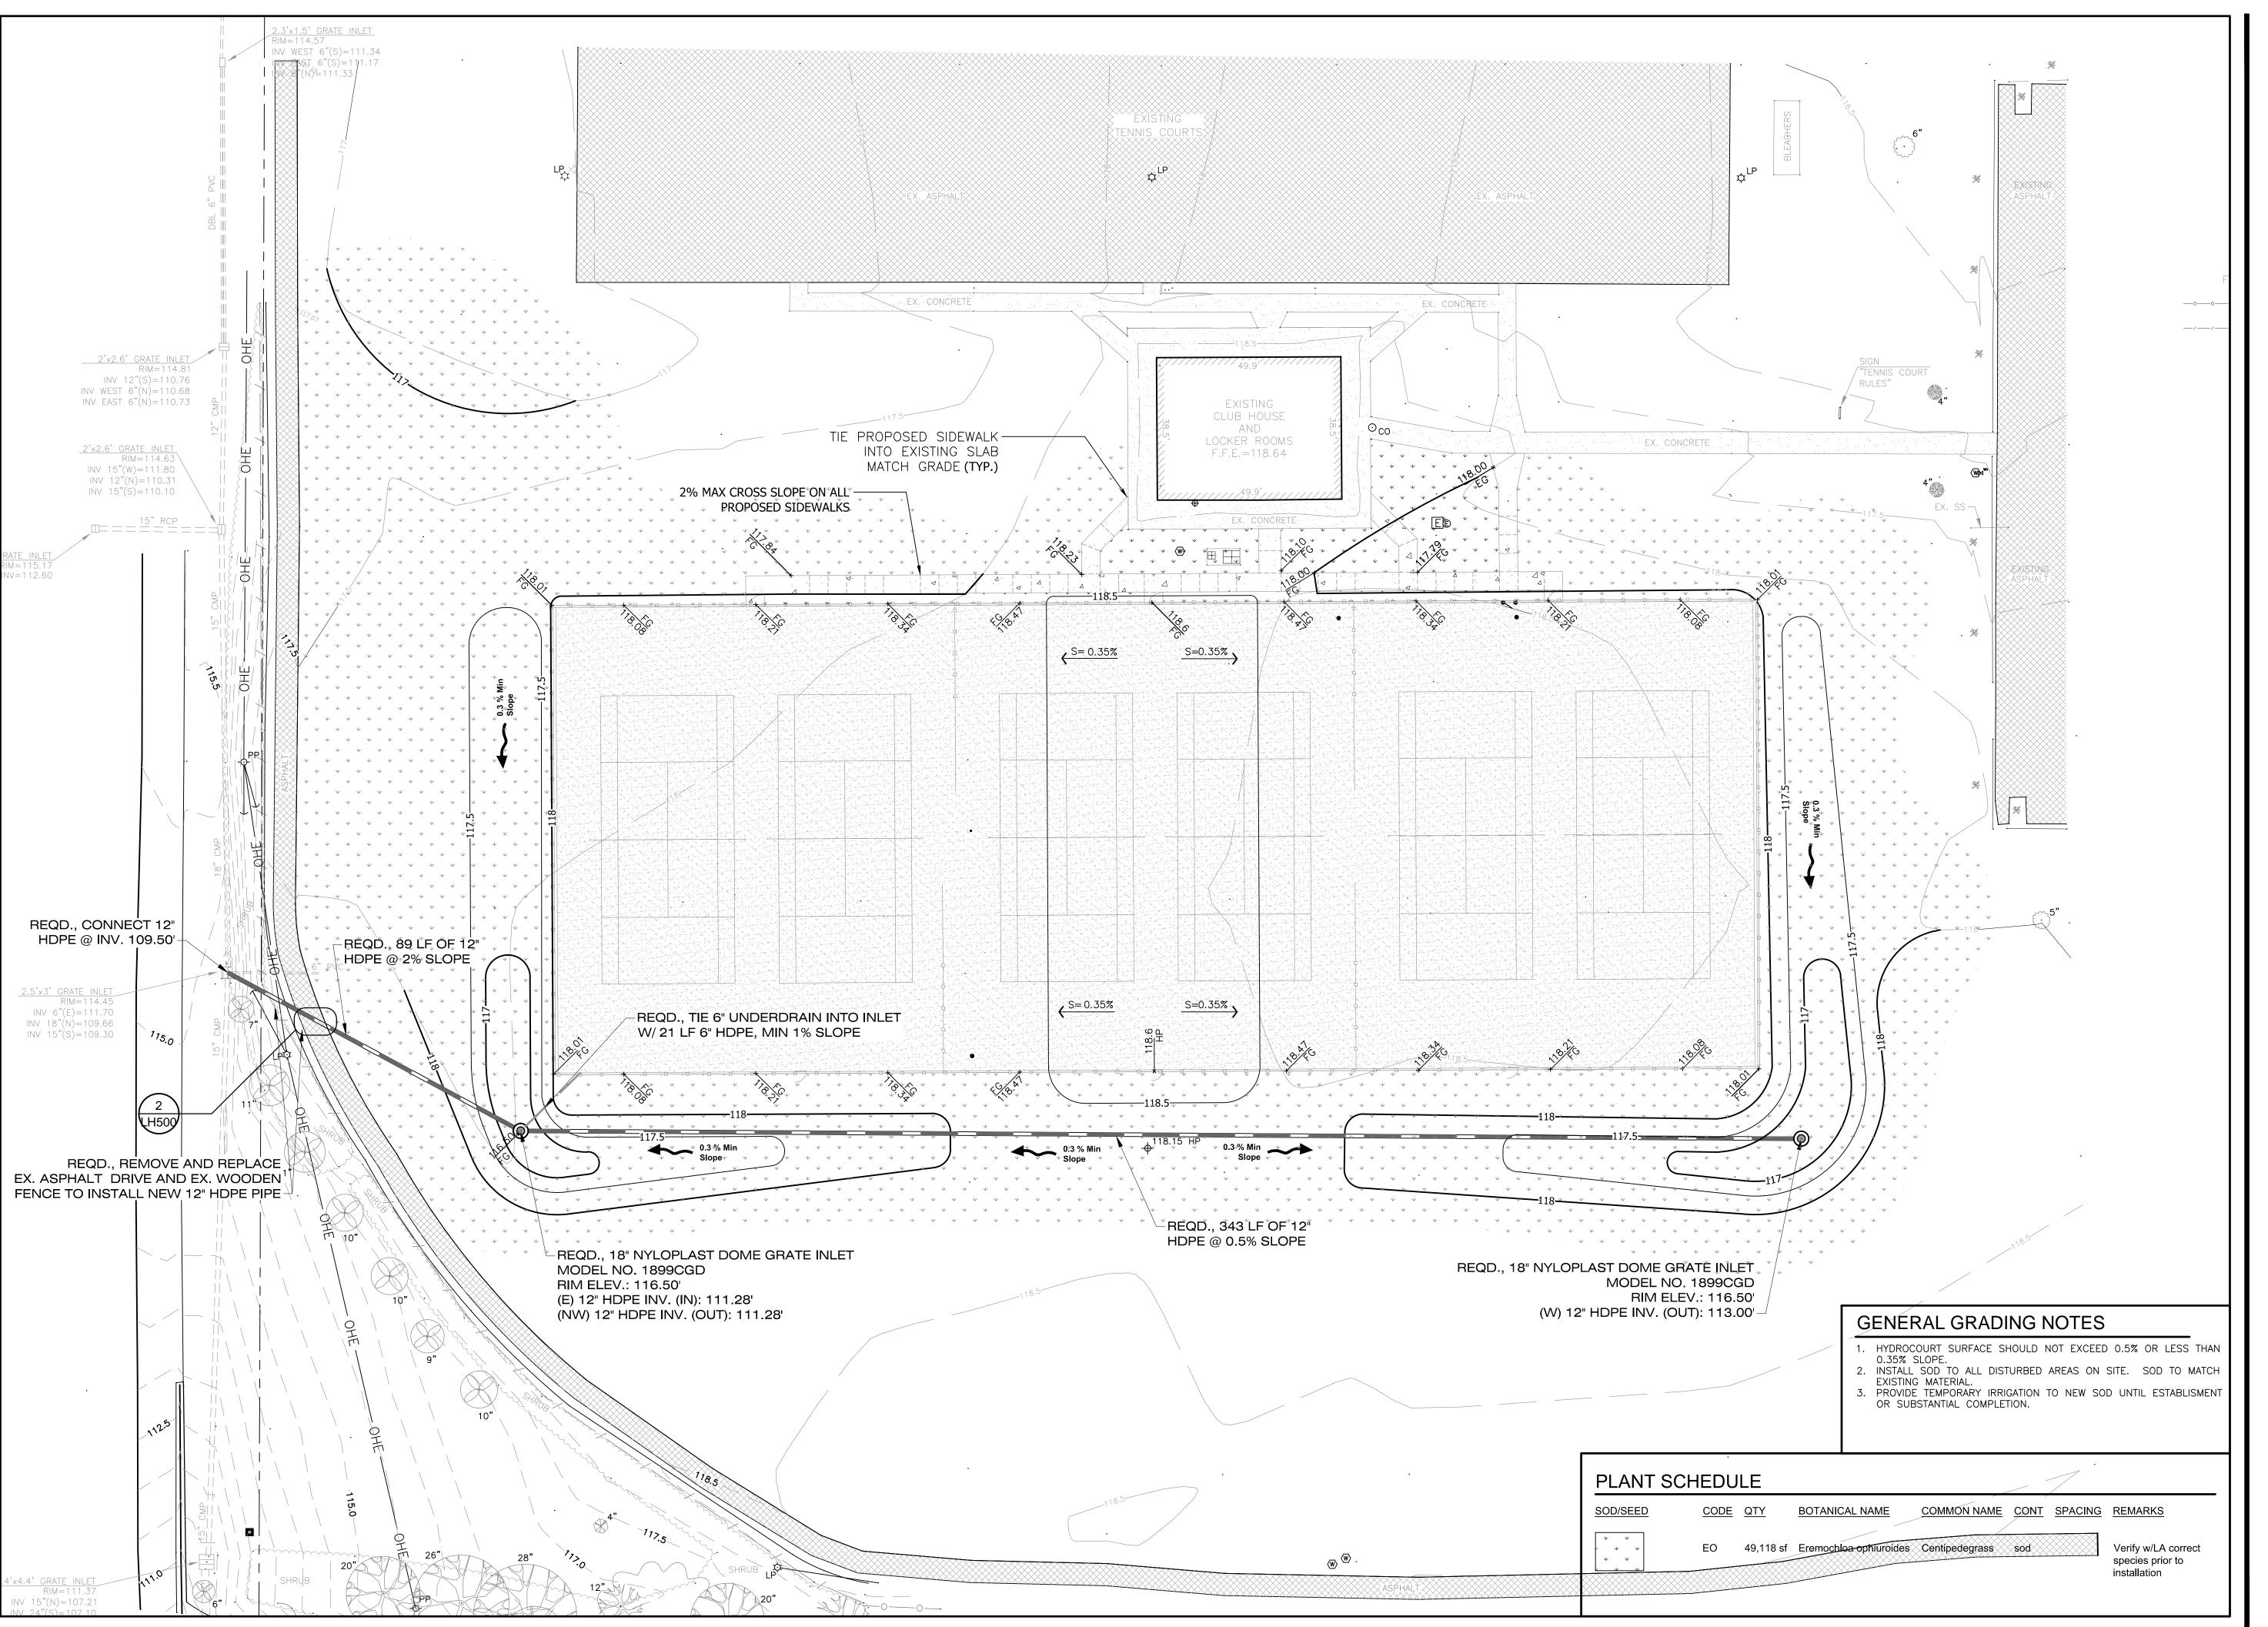



Stimpson Park Tenuis Court

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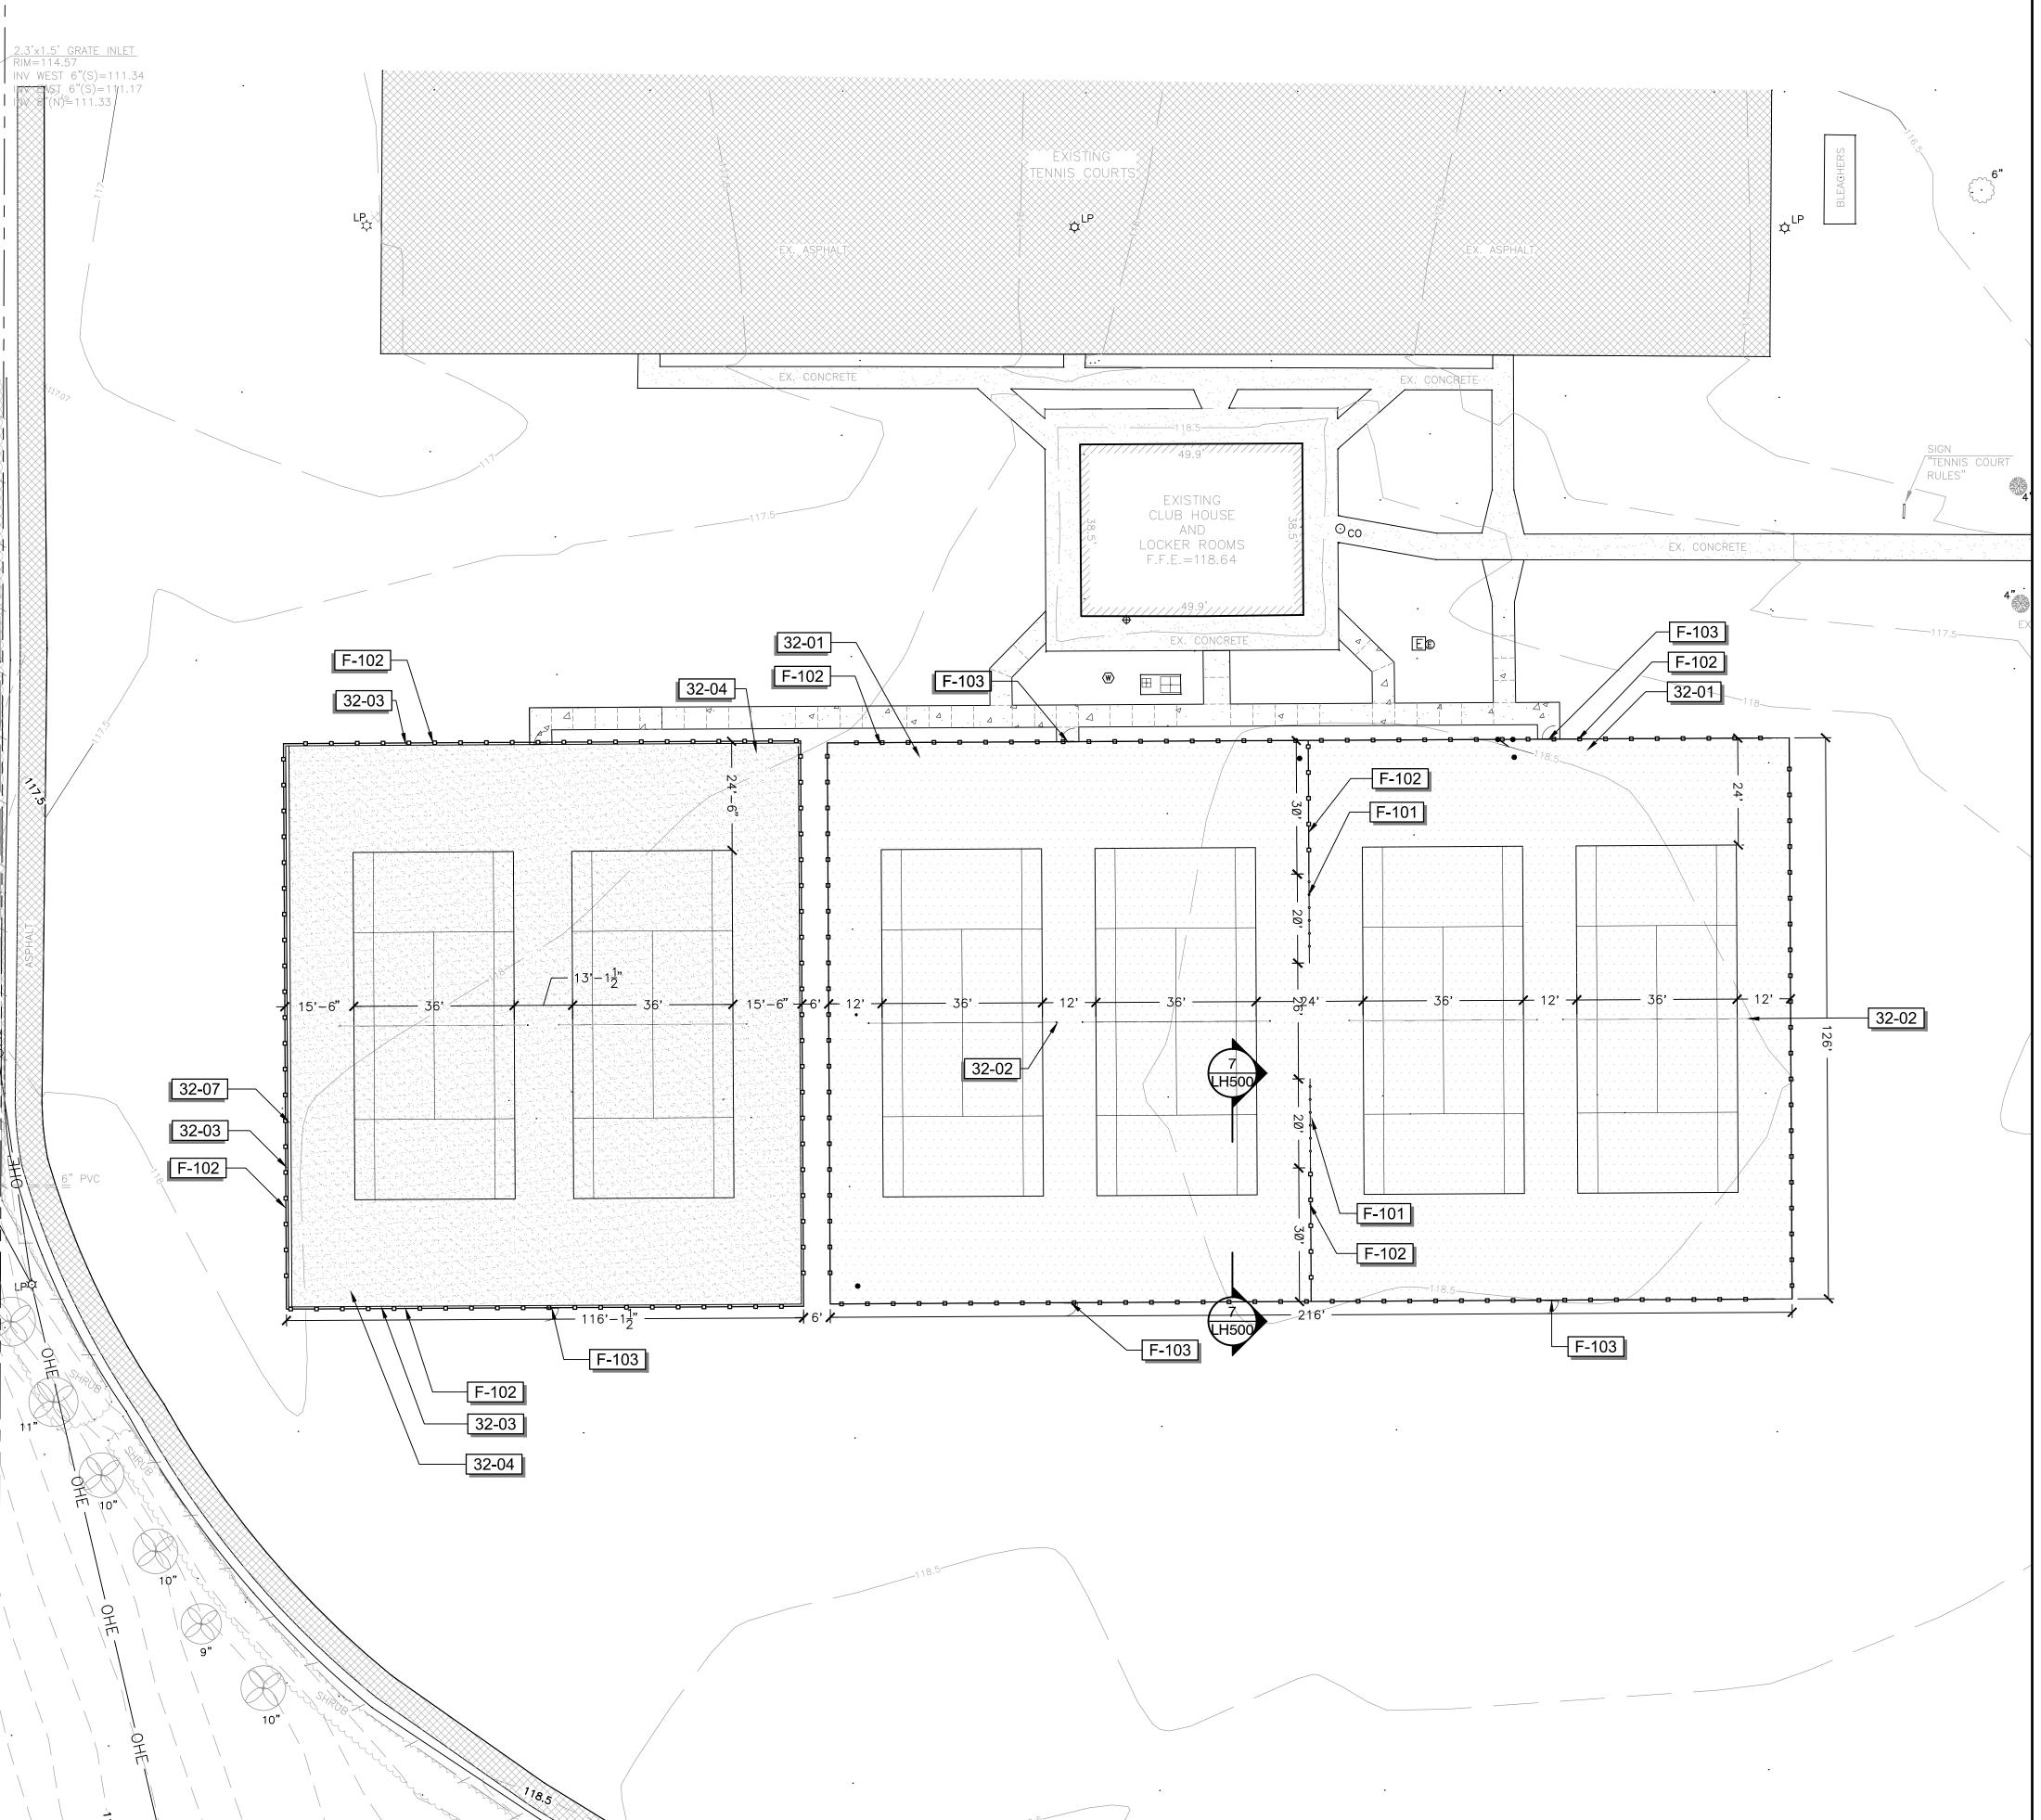
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Revisions / Submissions

HYDROCOURT GRADING PLAN

LG101

HYDROCOURT PLAN
Sada 1" = 20'



	REFE	RENCE NOTES SCHEDULE		
	SYMBOL	03 CONCRETE DESCRIPTION	<u>QTY</u>	DETAIL
	03-01	5` CONCRETE SIDEWALK	1,679 sf	9/LH500
	<u>SYMBOL</u>	32 EXTERIOR IMPROVEMENTS DESCRIPTION	QTY	<u>DETAIL</u>
	32-01	ASPHALT ATHLETIC SURFACING	27,216 sf	1/LH501
	32-02	ASPHALT POST & NET ASSEMBLY, EQUAL TO OR BETTER THAN EDWARDS 40LS,	4	3/LH500
	32-03	6" CONCRETE CURB	484 <b>I</b> f	2/LH501
	32-04	HYDROCOURT ATHLETIC SURFACING	14,412 sf	2/LH501
	32-05	CLAY POST & NET ASSEMBLY, EQUAL TO OR BETTER THAN EDWARDS 40LS,	2	5/LH500
	32-07	6" PRO SERIES TRENCH DRAIN	126 If	8/LH500
	<u>SYMBOL</u>	FENCE DESCRIPTION	<u>QTY</u>	<u>DETAIL</u>
	F-101	4` COATED CHAINLINK FENCE	40 If	4/LH500
	F-102	10' COATED CHAINLINK FENCE	1,222 If	1/LH500
₩ 4	F-103	7` GATE	6	1/LH500





Stimpson Park Tenuis Courts

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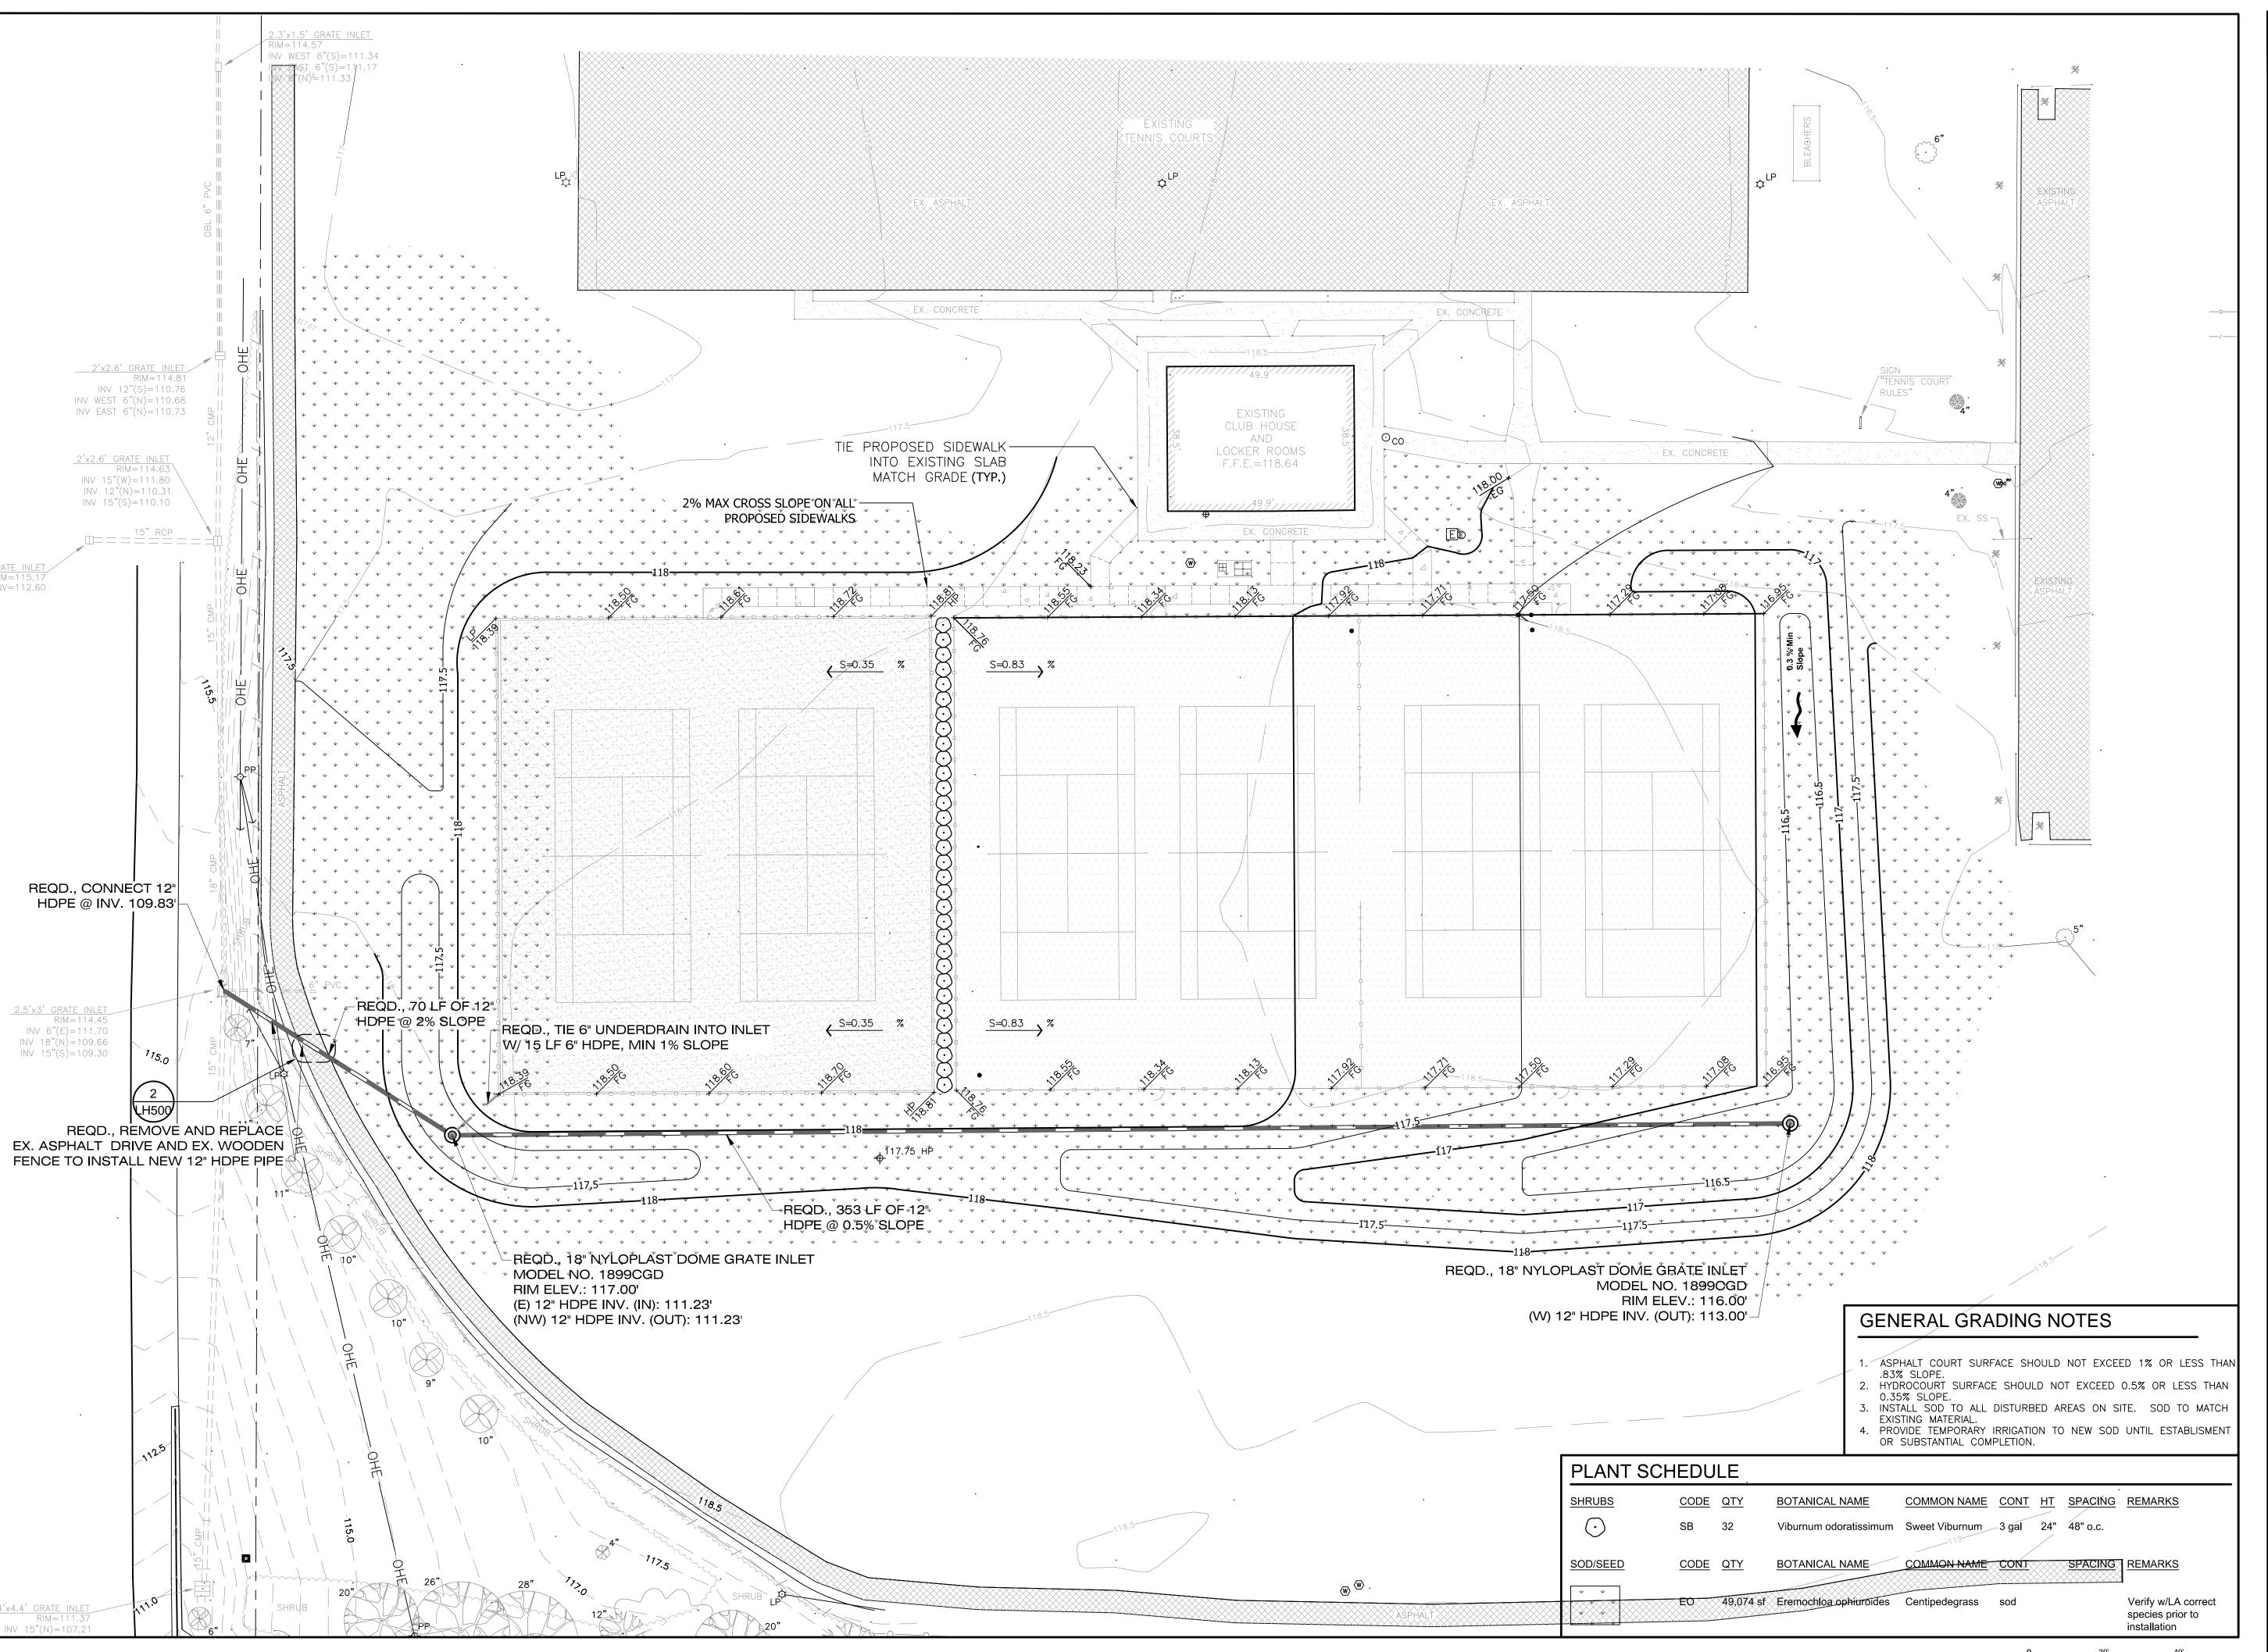
HYDROCOURT & ASPHALT PLAN

SP102


1 HYDROCOURT & ASPHALT PLAN

Scale: 1" = 20'

20' 40'





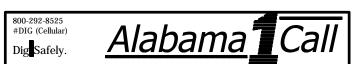

Stimpson Park Tenuis Court

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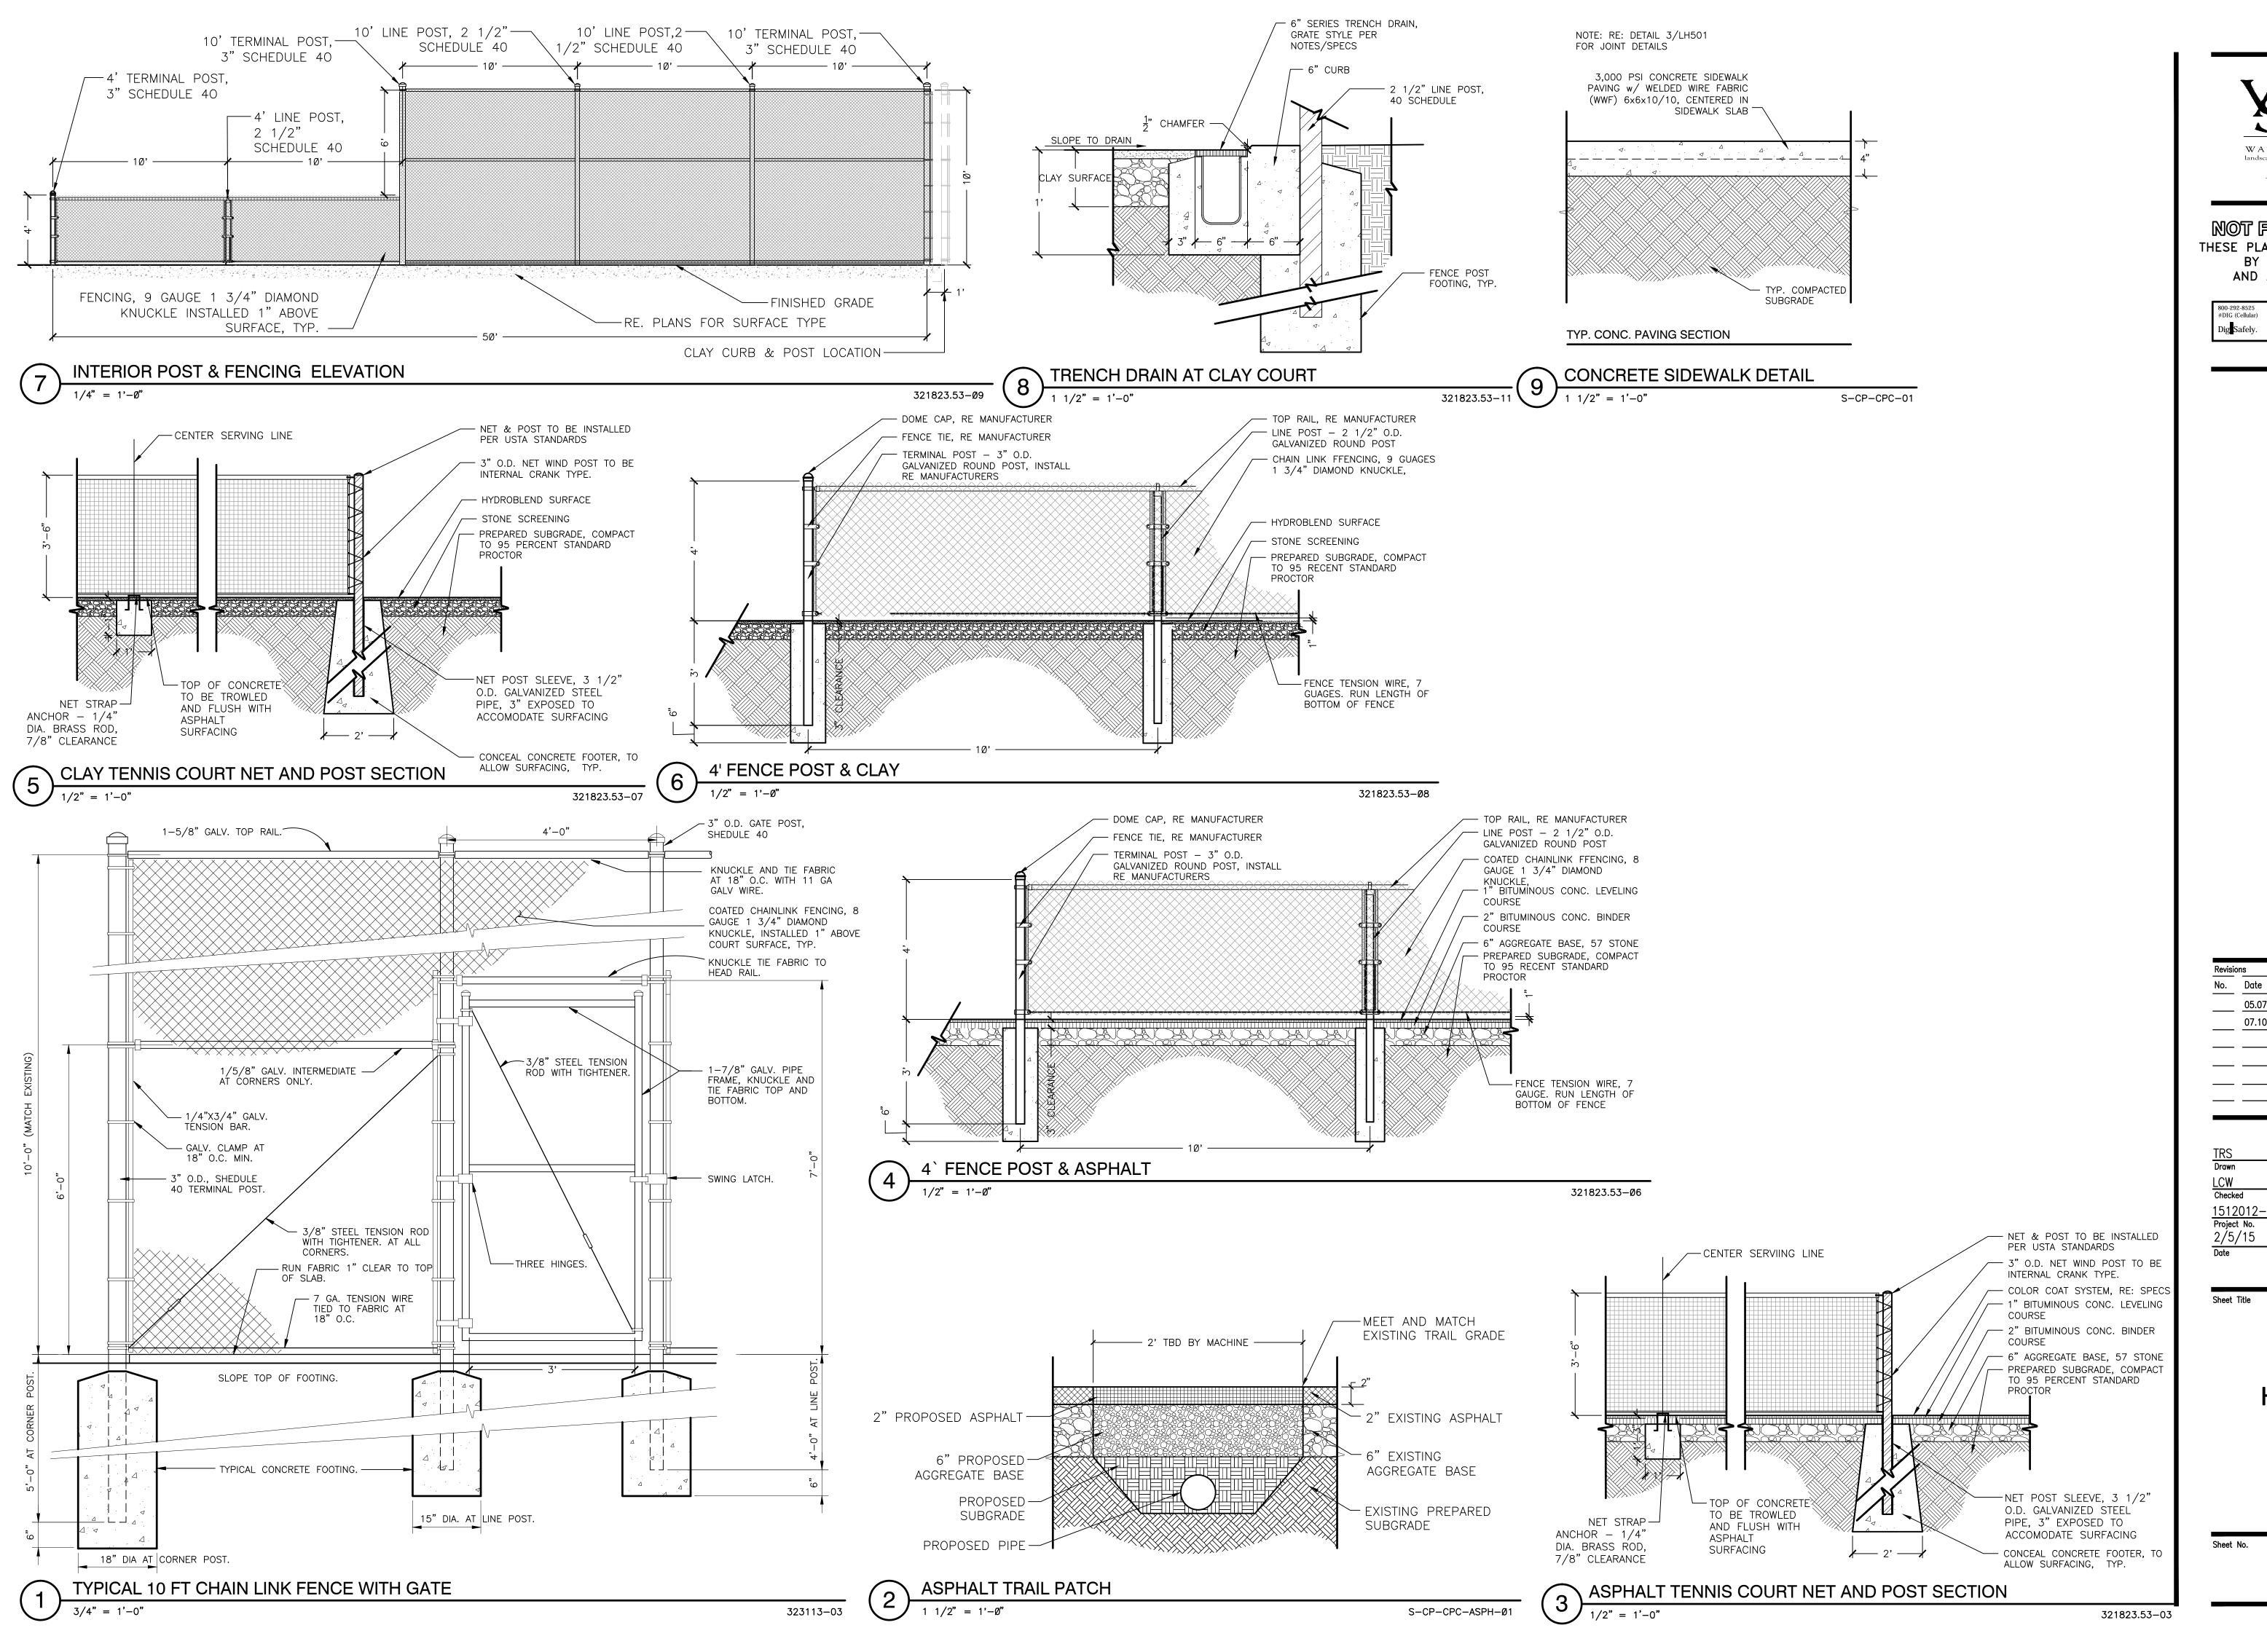
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Sheet Title

HYDROCOURT & ASPHALT COURT GRADING PLAN

LG102



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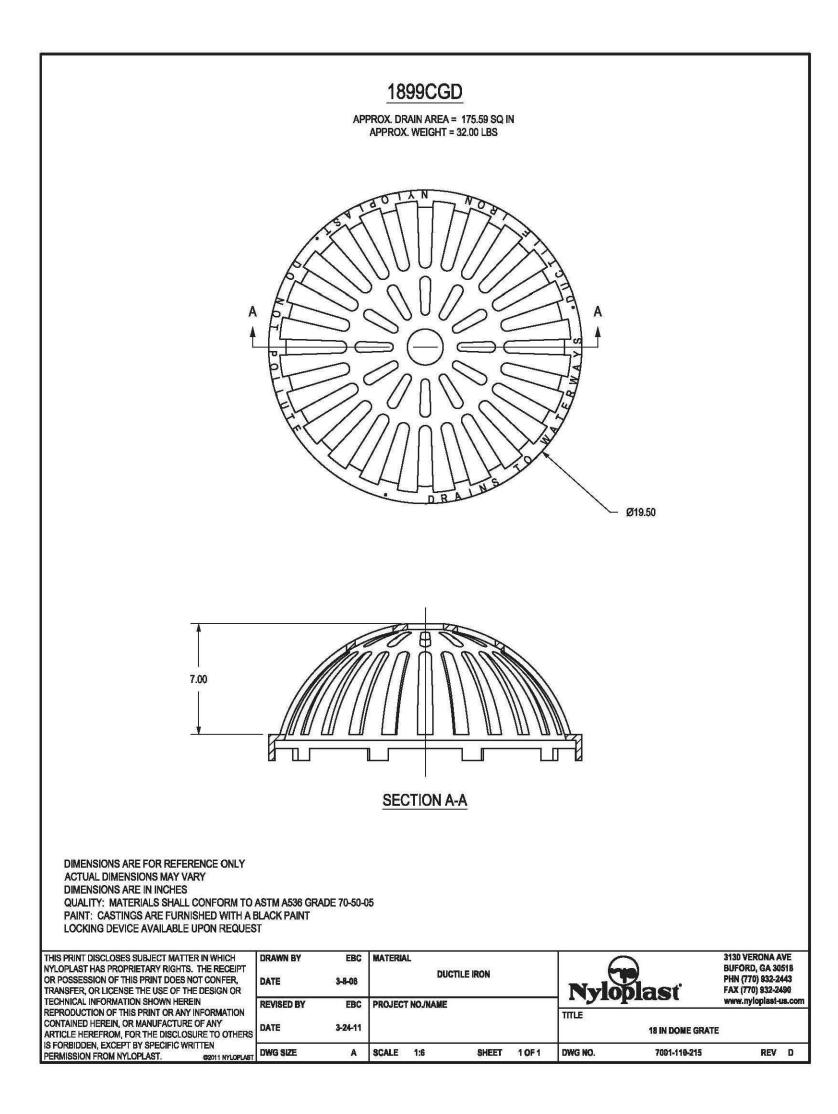
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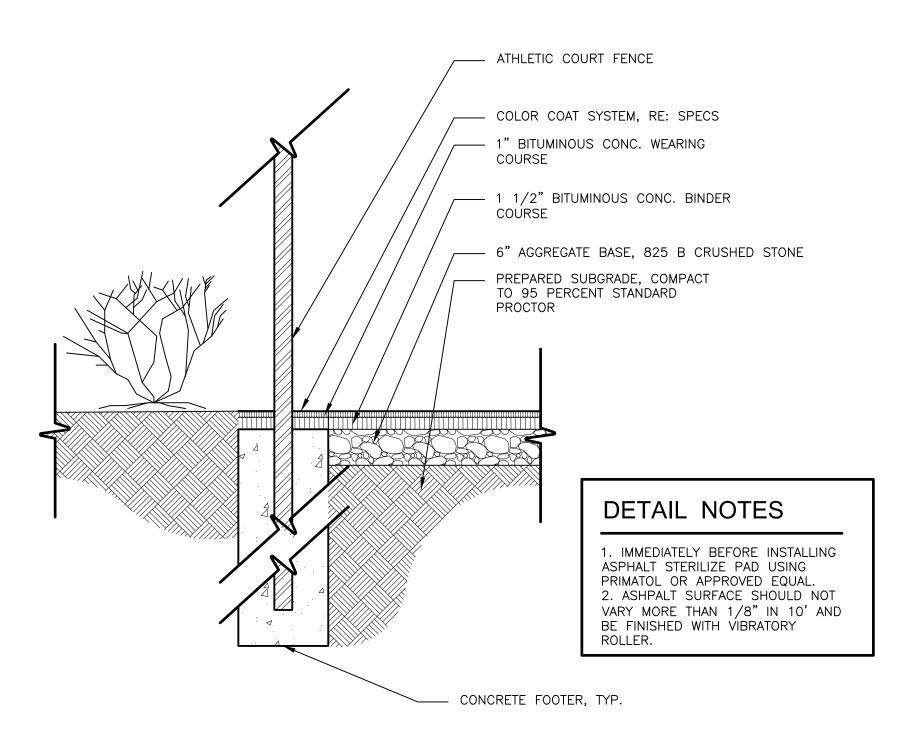
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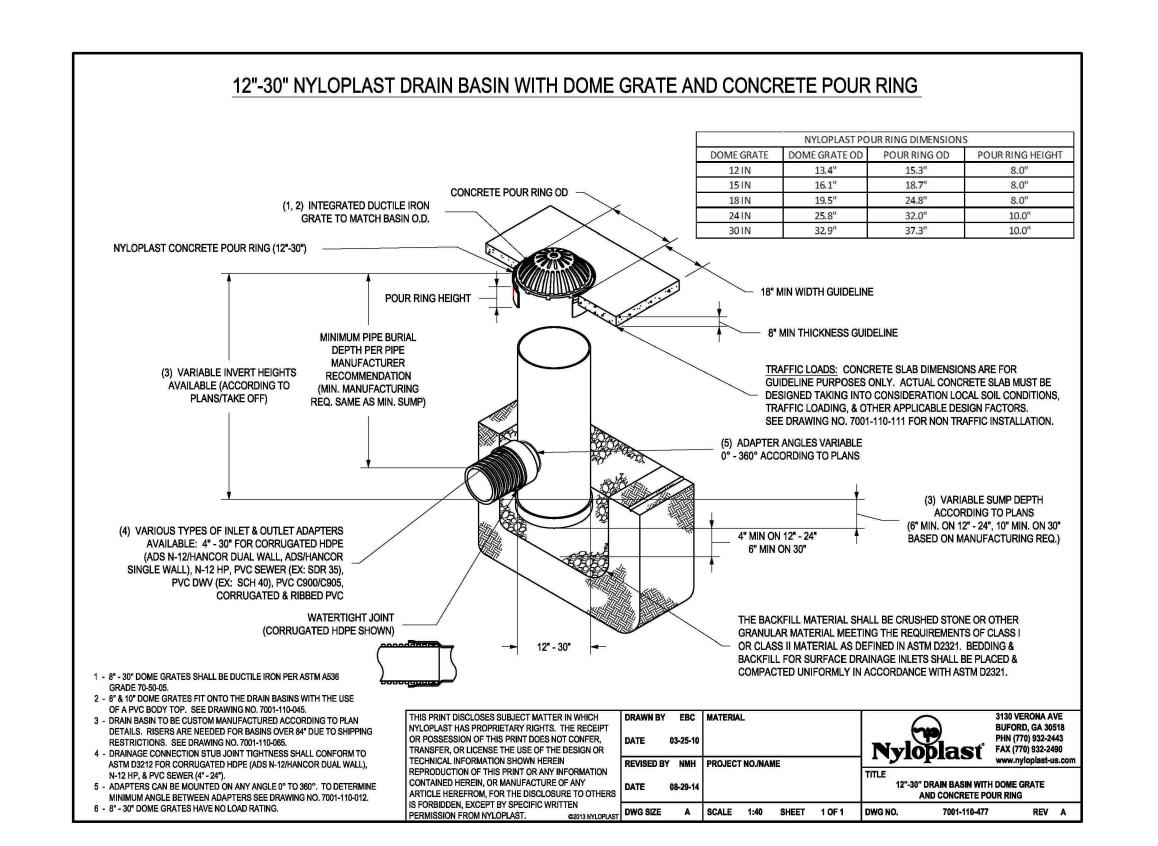
HARDSCAPE DETAILS

LH500




3 18 in Dome Grate Detail





\ PVC Pour Ring for Domed Grates

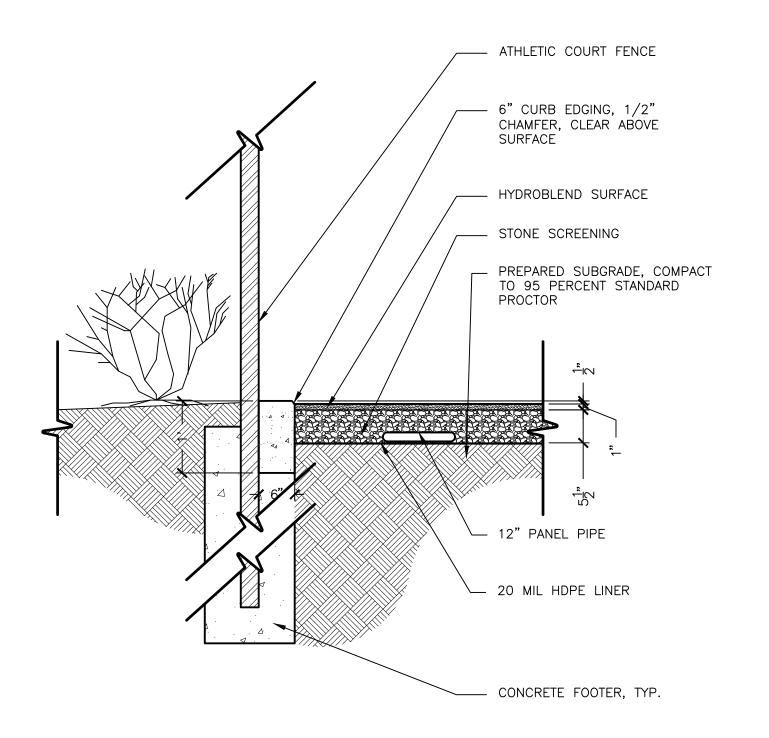

ATHLETIC ASPHALT COURT SECTION

ATHLETIC HYDROCOURT SECTION

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Sheet Title

HARDSCAPE **DETAILS** 

LH501

## SOIL EROSION AND SEDIMENT CONTROL NOTES

- 1. ALL DRAINAGE SWALES MUST BE GRASSED AND RIP-RAP MUST BE PLACED AS SHOWN TO CONTROL EROSION.
- 2. SILT FENCE MUST MEET THE REQUIREMENTS OF LOCAL JURISDICTIONAL AGENCY, SAID REQUIREMENTS AS SHOWN BY THESE PLANS.
- 3. DISTURBED AREAS SHALL BE VEGETATED AFTER CONSTRUCTION.
- 4. ADDITIONAL EROSION CONTROL MEASURES OR SILT BARRIERS TO BE PLACED AS SHOWN AND/OR DIRECTED BY THE PROJECT LANDSCAPE ARCHITECT AND/OR CITY ENGINEER AND/OR CITY OF FAIRHOPE INSPECTOR.
- 5. AS CONSTRUCTION PROGRESSES.. THE CONTRACTOR HEREBY AGREES TO STOP ALL WORK AND
- 6. RESTORE THESE AREAS IMMEDIATELY UPON NOTIFICATION BY THE LOCAL
- 7. JURISDICTIONAL INSPECTOR AND/OR PROFESSIONAL LANDSCAPE ARCHITECT AND OR CITY ENGINEER.
- 8. FOR ALL CONSTRUCTION ALONG AND/OR ACROSS WATERWAYS, BANK PROTECTION AND STABILIZATION SHALL BE REQUIRED AS PER LOCAL JURISDICTIONAL EROSION LAWS,
- 9. ALL EROSION CONTROL MEASURES SHALL BE IN PLACE PRIOR TO COMMENCING CONSTRUCTION AND SHALL BE MAINTAINED IN PROPER WORKING ORDER UNTIL ALL DISTURBED AREAS ARE STABILIZED. CONSTRUCTION ENTRANCE PADS SHALL BE INSTALLED BY THE CONTRACTOR AT CONSTRUCTION ACCESS POINTS PRIOR TO LAND DISTURBANCE AND SHALL BE MAINTAINED FOR THE DURATION OF THE PROJECT (NO DIRECT PAYMENT)
- 10. A COPY OF THE APPROVED LAND DISTURBANCE PLAN SHALL BE PRESENT ON THE SITE WHENEVER LAND DISTURBING ACTIVITY IS IN PROGRESS.
- 11. CONSTRUCT SILT FENCE ALONG THE DOWNSTREAM SIDE OF ALL PROPOSED FILL CONSTRUCTION.
- 12. EROSION CONTROL DEVICES SHALL BE INSTALLED IMMEDIATELY AFTER GROUND DISTURBANCE OCCURS. THE LOCATION OF SOME OF THE EROSION CONTROL DEVICES MAY HAVE TO BE ALTERED FROM THAT SHOWN ON THE APPROVED PLANS IF DRAINAGE PATTERNS DURING CONSTRUCTION ARE DIFFERENT FROM THE FINAL PROPOSED DRAINAGE PATTERNS. IT IS THE CONTRACTOR'S RESPONSIBILITY TO ACCOMPLISH EROSION CONTROL FOR ALL DRAINAGE PATTERNS CREATED AT VARIOUS STAGES DURING CONSTRUCTION. ANY DIFFICULTY IN CONTROLLING EROSION DURING ANY PHASE OF CONSTRUCTION SHALL BE REPORTED TO THE LANDSCAPE ARCHITECT AND OR CITY ENGINEER IMMEDIATELY.
- 13. CONTRACTOR SHALL MAINTAIN ALL EROSION CONTROL MEASURES UNTIL PERMANENT VEGETATION HAS BEEN ESTABLISHED. CONTRACTOR SHALL CLEAN OUT ALL SEDIMENT PONDS WHEN REQUIRED BY THE LANDSCAPE ARCHITECT AND OR CITY ENGINEER OR LOCAL JURISDICTIONAL INSPECTOR. CONTRACTOR SHALL INSPECT EROSION CONTROL MEASURES AT THE END OF EACH WORKING DAY TO ENSURE MEASURES ARE FUNCTIONING PROPERLY.
- 14. THE CONTRACTOR SHALL REMOVE ACCUMULATED SILT WHEN THE SILT IS WITHIN 12" OF THE TOP OF THE SILT FENCE UTILIZED FOR EROSION CONTROL. IN THE DETENTION POND, SILT SHALL BE REMOVED WHEN A DEPTH OF 18" HAS ACCUMULATED AT THE WEIR.
- 15. SILT BARRIERS TO BE PLACED AT DOWNSTREAM TOE OF ALL CUT AND FILL SLOPES.
- 16. THE CONTRACTOR SHALL FURNISH AND MAINTAIN ALL NECESSARY BARRICADES AROUND THE WORK AND SHALL PROVIDE PROTECTION AGAINST WATER DAMAGE AND SOIL EROSION.
- 17. TREE PROTECTION AND EROSION CONTROL MEASURES ARE TO BE ACCOMPLISHED PRIOR TO ANY OTHER CONSTRUCTION ON THE SITE AND MAINTAINED UNTIL PERMANENT GROUND COVER IS ESTABLISHED.
- 18. ALL SILT BARRIERS MUST BE PLACED AS ACCESS IS OBTAINED DURING CLEARING. NO GRADING SHALL BE DONE UNTIL SILT BARRIER AND DETENTION FACILITIES ARE CONSTRUCTED.
- 19. ALL SEDIMENT CONTROL DEVICES ARE TO BE CONSTRUCTED AND FULLY OPERATIONAL PRIOR TO ANY OTHER CONSTRUCTION OR GRADING.
- 20. ALL DISTURBED AREAS TO BE GRASSED PER CITY OF FAIRHOPE STANDARDS.
- 21. ALL SLOPES SHALL BE STABILIZED PER CITY OF FAIRHOPE STANDARDS.
- 22. GRASS AREAS DISTURBED DURING CONSTRUCTION SHALL BE REPLACED WITH GRASS IN KIND. IN AREAS OF INDECIPHERABLE GRASSES-USE CENTIPEDE.
- 23. IT IS THE CONTRACTOR'S RESPONSIBILITY TO PERFORM REQUIRED MAINTENANCE OF ALL EROSION AND SEDIMENT CONTROL DEVICES TO ENSURE THEIR FUNCTION AT ALL TIMES.

# UTILITY PLAN NOTES

- 1. THE CONTRACTOR SHALL NOTIFY WAS Design, Inc CONSTRUCTION SURVEILLANCE REPRESENTATIVE AND LOCAL JURISDICTIONAL INSPECTOR 48 HOURS BEFORE THE BEGINNING OF EACH PHASE OF CONSTRUCTION.
- 2. ALL WORK SHALL COMPLY WITH APPLICABLE STATE, FEDERAL, AND LOCAL CODES, AND ALL NECESSARY LICENSES AND PERMITS SHALL BE OBTAINED BY THE CONTRACTOR AT HIS EXPENSE UNLESS PREVIOUSLY OBTAINED BY THE OWNER/DEVELOPER.
- 3. THE CONTRACTOR SHALL IMMEDIATELY INFORM THE LANDSCAPE ARCHITECT AND/OR CITY ENGINEER OF ANY DISCREPANCIES OR ERRORS HE DISCOVERS IN THE PLAN.
- 4. DEVIATION FROM THESE PLANS AND NOTES WITHOUT THE PRIOR CONSENT OF THE OWNER OR HIS REPRESENTATIVE OR THE LANDSCAPE ARCHITECT AND/OR CITY ENGINEER MAY BE CAUSE FOR THE WORK TO BE UNACCEPTABLE.
- 5. THE CONTRACTOR SHALL COORDINATE LOCATION AND INSTALLATION OF ALL UNDERGROUND UTILITIES AND APPURTENANCES TO MINIMIZE DISTURBING CURBING, PAVING AND COMPACTED SUBGRADE.
- 6. UTILITY COORDINATION SHALL BE INCLUDED IN THE PROJECT SCHEDULE AND IT IS THE RESPONSIBILITY OF THE CONTRACTOR TO ASSURE THAT THE PROJECT SCHEDULE INCLUDES THE NECESSARY RELOCATION. THE CONTRACTOR SHOULD SEEK ASSISTANCE FROM ALL UTILITY COMPANIES TO LOCATE AND PROTECT THEIR FACILITIES.
- 7. THE CONTRACTOR SHALL BE RESPONSIBLE FOR ANY DAMAGE DONE BY HIS EQUIPMENT TO EXISTING UTILITIES, AND CITY OF FAIRHOPE PROPERTY.
- 8. ALL WATER AND SANITARY SEWER CONSTRUCTION METHODS AND MATERIALS SHALL CONFORM TO THE FAIRHOPE UTILITIES COMPANIES STANDARD SPECIFICATIONS.
- 9. ALL EXCESS MATERIAL FROM EXCAVATION SHALL BE DISPOSED OF BY THE CONTRACTOR. COST FOR THIS WORK SHALL BE INCLUDED IN OTHER ITEMS OF WORK.
- 10. BEDDING REQUIREMENTS SPECIFIED HEREIN ARE TO BE CONSIDERED AS MINIMUMS FOR RELATIVELY DRY, STABLE EARTH CONDITIONS. ADDITIONAL BEDDING SHALL BE REQUIRED FOR ROCK TRENCHED AND WET AREAS. THE CONTRACTOR SHALL HAVE THE RESPONSIBILITY TO PROVIDE SUCH ADDITIONAL BEDDING AS MAY BE REQUIRED TO PROPERLY CONSTRUCT THE WORK.

# **GRADING AND DRAINAGE NOTES**

- 1. THE CONTRACTOR SHALL FURNISH AND MAINTAIN ALL NECESSARY BARRICADES AROUND WORK AND SHALL PROVIDE PROTECTION AGAINST WATER DAMAGE AND SOIL EROSION.
- 2. ALL SILT BARRIERS MUST BE PLACED AS ACCESS IS OBTAINED DURING CLEARING. NO GRADING SHALL BE DONE UNTIL SILT BARRIER AND DETENTION FACILITIES ARE CONSTRUCTED.
- 3. ALL SEDIMENT CONTROL DEVICES ARE TO BE CONSTRUCTED AND FULLY OPERATIONAL PRIOR TO ANY OTHER CONSTRUCTION OR GRADING.
- 4. ALL SLOPES SHALL BE STABILIZED AS SOON AS POSSIBLE.
- 5. COMPACTION OF THE BACKFILL OF ALL TRENCHES SHALL BE COMPACTED TO THE DENSITY OF 95% OF THEORETICAL MAXIMUM DRY DENSITY (ATM D698). BACKFILL MATERIAL SHALL BE FREE FROM ROOTS, STUMPS OR OTHER FOREIGN DEBRIS AND SHALL BE PLACED AT OR NEAR OPTIMUM MOISTURE. CORRECTION OF ANY TRENCH SETTLEMENT WITHIN A YEAR FROM THE DATE OF APPROVAL WILL BE THE RESPONSIBILITY OF THE CONTRACTOR.
- 6. ALL FILL MATERIAL TO BE UTILIZED ON THE PROJECT SHALL BE FREE OF ORGANIC OR OTHERWISE DELETERIOUS MATERIALS AND COMPACTED TO MINIMUM DRY DENSITIES CORRESPONDING TO 95% OF MAXIMUM DRY DENSITY AS OBTAINED BY STANDARD PROCTOR, ASTM D698 AND AT LEAST 98% OF STANDARD PROCTOR WITHIN 1 FOOT BELOW PAVEMENT SUBGRADE. FILL SHALL BE PLACED IN LIFTS NOT TO EXCEED 6 INCHES IN COMPACTED FILL THICKNESS. A REPORT FROM A GEOTECHNICAL LANDSCAPE ARCHITECT AND/OR CITY ENGINEER WILL BE REQUIRED BY THE LOCAL JURISDICTIONAL INSPECTOR.
- 7. MAXIMUM SLOPE OF EMBANKMENT SHALL BE 3.0 FEET HORIZONTAL TO 1.0 FOOT VERTICAL.
- 8. PROPOSED CONTOUR INTERVALS ARE AS LABELED. ALL PROPOSED CONTOURS ARE FINISHED GRADES.
- 9. THE CONTRACTOR WILL INSURE THAT POSITIVE AND ADEQUATE DRAINAGE IS MAINTAINED AT ALL TIMES WITHIN THE PROJECT LIMITS.
- 10. EXCESS EARTH CUT MATERIAL, IF ANY, SHALL BECOME THE RESPONSIBILITY OF THE CONTRACTOR AND SHALL BE REMOVED FROM THE SITE UNLESS OTHERWISE APPROVED TO BE PLACED ON SITE BY THE OWNER.
- 11. THE CONTRACTOR SHALL PROVIDE ANY EXCAVATION AND MATERIAL SAMPLES NECESSARY TO CONDUCT REQUIRED SOIL TESTS. ALL ARRANGEMENTS AND SCHEDULING FOR THE TESTING SHALL BE THE CONTRACTOR'S RESPONSIBILITY.
- 12. SOILS TESTING AND ON-SITE INSPECTION SHALL BE PERFORMED BY AN INDEPENDENT GEOTECHNICAL ENGINEER. THE SOILS ENGINEER SHALL PROVIDE COPIES OF TEST REPORTS TO THE CONTRACTOR, THE OWNER AND THE OWNER'S REPRESENTATIVE AND SHALL PROMPTLY NOTIFY THE OWNER, HIS REPRESENTATIVE AND THE CONTRACTOR SHOULD WORK PERFORMED BY THE CONTRACTOR FAIL TO MEET THESE SPECIFICATIONS.




NOT FOR CONSTRUCTION

THESE PLANS HAVE NOT BEEN APPROVED

BY THE GOVERNING AGENCY

AND ARE SUBJECT TO CHANGE.

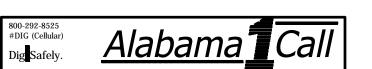

nyson Park Tenuis Court
Fairhope, Alabama

Revisi	ons	-
No.	Date	Revisions / Submissions
	05.07.15	90% CD
	07.10.15	ISSUED FOR BID

TRS
Drawn
LCW
Checked
1512012-033
Project No.
2/5/15
Date

Registration

Registration

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Sheet Title

**GENERAL NOTES** 

No.